

#### **TANANA CHIEFS CONFERENCE**

# REQUEST FOR PROPOSALS FOR CHIEF PETER JOHN TRIBAL BUILDING RESTROOM UPGRADES: FLOORS 2, 3, 4 AND 6 PROFESSIONAL DESIGN SERVICES

### Issued By:

Tanana Chiefs Conference 122 First Avenue, Suite 600 Fairbanks, Alaska, 99701

November 30, 2020

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#### Attachments

- A. CPJTB 5<sup>th</sup> Floor Lobby Renovation Construction Drawings by Stantec
- B. CPJTB 5<sup>th</sup> Floor Lobby Renovation Photos
- C. CPJTB 2<sup>nd</sup>, 3<sup>rd</sup>, 4<sup>th</sup> and 6<sup>th</sup> floor plans
- D. TCC Sample Contract To be provided by Addenda

#### I. SOLICITATION

Tanana Chiefs Conference (TCC) is soliciting proposals for professional architectural and interior design services to renovate the community restrooms and a single user restroom in the Chief Peter John Tribal Building located in Fairbanks, Alaska.

The community restrooms on the 2<sup>nd</sup>, 3<sup>rd</sup> and 4<sup>th</sup> floors will replicate the 5<sup>th</sup> floor restroom in all aspects of design which was upgraded in 2015. Attachment A: 5<sup>th</sup> Floor Construction Drawings and Attachment B: Completion Photos are provided as part of this RFP.

**RFP Download**: Interested parties may view and download RFP documents at the following locations:

- The Plans Room: <a href="http://www.theplansroom.com/">http://www.theplansroom.com/</a>
- Associated General Contractors of Alaska Plans: <a href="http://www.agcak.org/agc-online-plans.html">http://www.agcak.org/agc-online-plans.html</a>
- Tanana Chiefs Conference: <a href="https://tananachiefs.org">https://tananachiefs.org</a> Refer to "Bid Information"
- Proposers may also request the RFB by contacting: Arcadis Project Administrator, Tara Zhugar at tara.zhugar@arcadis.com

**Registration/Questions:** Each firm must register to submit questions and receive addenda notifications. To register, please send an email to Project Administrator, Tara Zhugar at <a href="mailto:tara.zhugar@arcadis.com">tara.zhugar@arcadis.com</a> and Project Manager, Marion Bella at <a href="mailto:marion.bella@arcadis.com">marion.bella@arcadis.com</a>. Include firm name, address, telephone and name/email address of contact person.

**Written Questions and Addenda Publication:** All questions must be submitted in writing on or before December 11, 2020 by 2:00 p.m. Alaska Time (AKT). The last Addendum will be published on or before December 14, 2020.

**Proposal Submission Deadline:** Proposals must be received no later than December 18, 2020 2:00 PM Alaska Time (AKT), at the office of Arcadis, 410 Second Ave, Suite 206, Fairbanks, Alaska 99701, Attention: Marion Bella or via email to marion.bella@arcadis.com. Proposals received after the time announced will not be considered, unless otherwise determined by TCC.

Due to COVID-19 protocols:

- Emailed electronic proposals will be accepted. Recommend setting a delivery and read receipt.
- Proposals will not be opened publicly.

Faxed proposals will not be accepted.

#### II. PROJECT OVERVIEW

Headquartered in Fairbanks, Alaska, Tanana Chiefs Conference (TCC) is a non-profit Tribal Organization that provides health services, education, training, and work force development opportunities to more than 10,000 Alaska Natives located in 42 Villages throughout Interior Alaska. TCC's primary office building is the Chief Peter John Tribal Building (CPJTB) located at 122 First Avenue.

The Restroom Upgrades Project is comprised of two main design components; 1) replication of the 5<sup>th</sup> floor restroom upgrades in both architecture and interior design for the community restrooms on floors 2, 3, and 4; and 2) a complete interior renovation of the 6<sup>th</sup> floor single user restroom on the west side of the building.

The general scope of renovation work for the restrooms includes new floor, wall and ceiling finishes, new built-in casework, new fixtures, and related mechanical/electrical/lighting revisions and improvements.

See CPJTB 2<sup>nd</sup>, 3<sup>rd</sup>, 4<sup>th</sup> and 6<sup>th</sup> floor plans in Attachment C for current layout.

#### III. PROJECT SCHEDULE

It is anticipated that a Notice of Intent Award will be issued to the selected A/E team on December 21, 2020. Upon final negotiation of scope, schedule and level-of-effort for the Project, the firm should be prepared to begin work on the Project immediately after the fees are negotiated and the firm is issued a Notice to Proceed which is expected to be by January 4, 2021.

Designated design phases, including review periods, are projected to take approximately two (2) months immediately after which the project will be bid for construction. Bidding/construction activities and furnishings/equipment procurement/installation is anticipated to take approximately six (6) months.

#### IV. SCOPE OF WORK

TCC is requesting proposals from qualified individuals, firms or teams of professionals to provide A/E Services for the CPJTB Restroom Upgrades: Floors 2, 3, 4 and 6 Project. These services will include architectural/interior design, structural (if needed), mechanical, electrical, cost estimating, and other specialties as may be necessary.

#### Scope of Work includes:

- Construction Drawings Floors 2, 3 and 4: The A/E shall provide complete final stamped bid-ready construction drawings for the proposed project. Renovation of the 5<sup>th</sup> floor public toilet layouts and finishes are to be used as the basis of this project's design. Drawings and Submittals shall be provided at the 65%, 95% and Final bid-ready construction documents. Drawings and Specifications shall embody adequate design documentation with details, dimensions, notational information and other data to ensure the Construction Contractor has a complete understanding of all elements of work.
- Construction Drawings 6<sup>th</sup> Floor: The A/E shall complete final stamped bid-ready construction drawings for the proposed project. Submittals shall be provided at the following design phases: 65% Design Development, 95% and Final bid-ready construction documents. Drawings and Specifications shall be developed from approved preliminary design documents and they shall embody adequate design documentation with details, dimensions, notational information and other data to ensure the Construction Contractor has a complete understanding of all elements of work.

Construction drawings shall adhere to uniform CAD standards. Final construction drawings shall be signed and sealed by the architect and engineer licensed in the State of Alaska under whose discipline the work relates.

• Specifications: The A/E shall complete general requirement specifications (Division 1) and construction specifications (Divisions 2 thru 49) to support all labor, material, and equipment needs for construction. Division 1 specifications shall be edited to the unique requirements of TCC and this project. Division 2 through 49 specifications shall be complete and thorough, covering all aspects of the project and shall define the required quality of the material and workmanship. Execution requirements shall be specific enough to produce the desired results and performance without unnecessarily limiting the Contractor in the choice of methods.

The specifications format shall be the latest CSI Master Format Edition to coincide with the latest RS Means Building Construction Cost Data.

The A/E shall also submit product information or vendor cut sheets in support of major systems, components, finishes, and equipment.

• Cost Estimates: The A/E Team will provide a total of one (1) cost estimate at the 65% phase. Cost estimates shall be the best estimate available of construction costs based

upon a competitive bid procurement. Cost estimate format shall use the latest CSI Master Format Edition divisions.

- Design Review Meetings: The A/E shall conduct a design review meeting over a
  web-based communication platform such as Microsoft Teams or Zoom, to discuss the
  TCC review comments at the 65%, and 95% design phases for the 6<sup>th</sup> Floor single
  user restroom and 65% and 95% phases for floor 2, 3 and 4 before proceeding with
  the next submittal.
- Bidding Phase Services A/E services during the bidding phase will include, but are
  not limited to, review of contractor design questions and preparation of responses
  during the contractor bid process.
- Construction Administration A/E construction administration services will include, but are not limited to, attending weekly coordination meetings (via teleconference for those unable to participate in-person) and site visits, review and coordinate submittals, prepare RFI responses, review RFPs and make recommendations, develop supplemental design instructions as necessary, review pay estimates, participate in substantial and final inspections and punch listing, and review/approve O&M Manuals.
- As-Built Drawings The A/E team shall submit as-built drawings to the Owner in both AutoCAD and PDF electronic formats for the project records and future maintenance.

#### V. PROJECT DELIVERABLES

Permit Documents (65% Design Development)

- Drawings: (4) hard copies, 11x17; electronic PDF
- Specification Outline: (4) hard copies, 8.5x11; electronic PDF
- Cost Estimate: (4) hard copies, 8.5x11; electronic PDF

#### Signed Construction Documents

- Drawings: (4) hard copies, 11x17; (4) hard copies, 22x34
- AutoCAD .dwg files of Drawings
- Specification Outline: (4) hard copies, 8.5x11; electronic PDF
- Word .doc files of specifications
- Digital copy of Drawings and Specification Files

#### Record Drawings

- Drawings: (4) hard copies, 11x17
- AutoCAD .dwg files of Drawings
- Digital copy of Drawings and Specification Files

#### VI. PROPOSAL FORMAT

Proposals should respond directly to the evaluation criteria for this project. Additional material (other than that requested below) is not required or desired. Clarity and brevity are encouraged. Limit submittals as follows:

Cover Letter 1 pages maximum

Response to Criteria A-D 5 pages maximum

Team Member Resumes 2 pages maximum per person

Addenda Acknowledgement Form attached to RFP

Design Fee Proposal Form attached to RFP

One page is defined as one side of a standard 8  $\frac{1}{2}$  " by 11" sheet of paper. Submittals shall be presented in 8  $\frac{1}{2}$  " by 11" format. A limited number of larger sheets may be included if folded to the 8  $\frac{1}{2}$ " by 11" format. Larger sheets will count as two pages. Cover letter, resumes, forms, tabs and/or divider pages do not count against the maximum page limits. Please use a minimum 10-point font size. Small print that is difficult to read may negatively influence evaluation of the submittal.

The following identifies specific content expected for each section.

#### **Cover Letter**

The cover letter shall briefly introduce your team and state your understanding of the project and explain why the respondent team is the best qualified to provide those services. Give the name and contact information of the person who is authorized to make representations and commitments for your organization. The letter should be signed by an officer or other individual with the authority to bind the organization.

#### A. Relevant Firm Experience (35 points)

A/E firm to illustrate its demonstrated ability to manage and successfully complete projects of comparable design, scope and complexity, including experience of firm and key employees in providing architect and engineering design services to tribal organizations, including TCC. For each project listed, provide information concerning: i) the type of project, price or budget range, name and location; ii) the original bid/proposal price and final contract price; iii) the original date scheduled for completion and the actual completion date; and iv) project references, name and contact information for the owner of the three most recent relevant projects your firm has completed.

#### B. Team Personnel (35 points)

Describe each team member's role and relevant project experience.

Provide an organizational chart indicating team organization, key personnel, team member firms/roles. Indicate if team members have previous experience working together.

Additionally, provide resumesfor key personnel noting educational background, relevant project experience and references with contact information for the two most recent relevant projects.

#### C. Capacity (10 points)

Describe current and proposed project commitments for each of the proposed team members during the project period. Provide an estimate of a percentage of time each team member will be able to commit to this project's success.

#### D. Fee Proposal Form (20 points)

Complete the Design Fee Proposal Form in Section XII of this RFP and include with the Proposal. Please submit fee proposal in a separate PDF file from proposal so pricing can be reviewed separately.

#### E. Addenda Acknowledgement Form

Complete the Addenda Acknowledgement Form in Section XIII of this RFP and include with the proposal.

#### VII. SELECTION PROCESS AND CRITERIA

Each proposal will be evaluated and scored by committee members. The highest scoring Firm will be issued a Notice of Intent to Award letter.

Selection Criteria/Weighting:

- A. Relevant Firm Experience (35)
- B. Team Personnel (35)
- C. Capacity (10)
- D. Design Fee Proposal (20)

Fee will be scored using the following formula:

Score =  $20 \times (2 \times \text{Lowest Proposed Price/Proposer's Price - 1})$ .

For example, Proposer A's fee is \$80,000 and was lowest price. Proposer B's fee is \$100,000.

Proposer A Score =  $20 \times (2 \times 80,000/80,000 - 1) = 20 \text{ points}$ Proposer B Score =  $20 \times (2 \times 80,000/100,000 - 1) = 12 \text{ points}$ 

#### VIII. SELECTION AND DESIGN SCHEDULE

The anticipated schedule for the Design Team selection process follows. All dates are approximate and contingent upon the completion of previous activities.

Request for Proposal Issued	November 30, 2020
Deadline for Questions (2:00 pm AKT)	December 11, 2020
Last Addenda Published	December 14, 2020
Proposal Submission Deadline (2:00 pm AKT)	December 18, 2020
Proposal Review	December 18, 2020
Notice of Intent to Award	December 21, 2020
Notice to Proceed	January 4, 2021
Permit Documents/65% Design Development Drawings	February 22, 2021
Permit Documents/65% DD Review Meeting	February 26, 2021
Signed Construction Documents	March 15, 2021

#### IX. PROJECT CONTRACT

Upon Notice of Intent to Award, the intent is for TCC to enter negotiations with the top-ranked Proposer. If for some reason an Agreement cannot be reached with the top-ranked Proposer, TCC reserves the right to terminate negotiations and commence negotiations with the second-ranked Proposer and so on. TCC also reserves the right to terminate the selection process at any point.

A sample contract will be provided by addenda for general reference.

#### X. SUBMITTAL REQUIREMENTS

To be considered, all Proposals must be delivered to the address below, on or before the deadline.

**Questions** – All questions regarding this RFP must be submitted in writing to Project Manager, Marion Bella at <a href="marion.bella@arcadis.com">marion.bella@arcadis.com</a>. Prior to 2:00 PM AKT on December 11, 2020. Written responses will be provided to all proposers via an addendum. Only questions answered by formal written addenda to the RFP will be binding; oral and other interpretations or clarifications will be without legal effect.

**Proposal Submission Deadline** – All Proposals must be received by Arcadis Fairbanks office no later than 2:00 PM AKT on December 18, 2020.

**Delivery Instructions** – mail, hand deliver or courier proposal package in a sealed envelope to:

Arcadis U.S., Inc. 410 Second Avenue, Suite 206 Fairbanks, Alaska, 99701

Mark the envelope to identify the project: "TCC CPJTB Restroom Upgrades: Floors 2, 3, 4 and 6 – Professional Design Services".

Emailed proposals can be sent to: marion.bella@arcadis.com

Faxed proposals will not be accepted.

#### XI. TERMS AND CONDITIONS

#### **Waiver of Minor Informalities**

TCC expressly reserves the right to waive minor informalities, negotiate changes or reject any and all proposals and to not award the proposed contract, if in its best interest. "Minor informalities" means matters of form rather than substance which are evident from the submittal or are insignificant matters that have negligible effect on price, quantity, quality, delivery or contractual conditions and can be waived or corrected without prejudice to the other Proposers.

#### **Proposal Preparation**

In submitting a proposal in response to this RFP, each Proposer acknowledges that TCC shall not be liable to any person, company or representative for any costs incurred in preparation of their proposal or any costs incurred in anticipation of TCC's action approving or disapproving any proposed agreement.

#### **Ownership of Proposals**

All proposals and other materials become the property of the Owner and may be returned only at the option of the Owner. Proposals will not be made public unless required by law.

#### XII. DESIGN FEE PROPOSAL FORM

	Design Firm		
	Address		
	City, State, Zip Code		
	Date		
	AK State Business L	icens	se #
Permit Documents/Signed Construction D	ocuments (Lump Sum):		
		(\$_	)
Words			Figure
Bidding (T&E, Not to Exceed):			
		(\$_	)
Words			Figure
Construction Administration (T&E, Not to I	Exceed):		
		(\$_	)
Words		. (	Figure
Total:		<b>/</b> ¢	\
Words		(\$_	Figure
 Lega	I Name of Proposing O	rgani	zation
Ву			
 Date			

#### XIII. ADDENDA ACKNOWLEDGEMENT FORM

Signature and Title

The Proposer acknowledges receipt of the following Addenda:

Addendum

No.
Addendum

No.
Dated:
Addendum

No.
Dated:
Initials:
Addendum

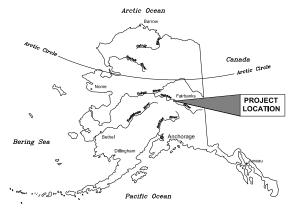
No.
Dated:
Initials:

Addendum

No.
Dated:
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Dated:
Date

Printed Name





**LOCATION MAP** 

# TANANA CHIEFS CONFERENCE

# CHIEF PETER JOHN TRIBAL BUILDING 5TH FLOOR LOBBY RENOVATION

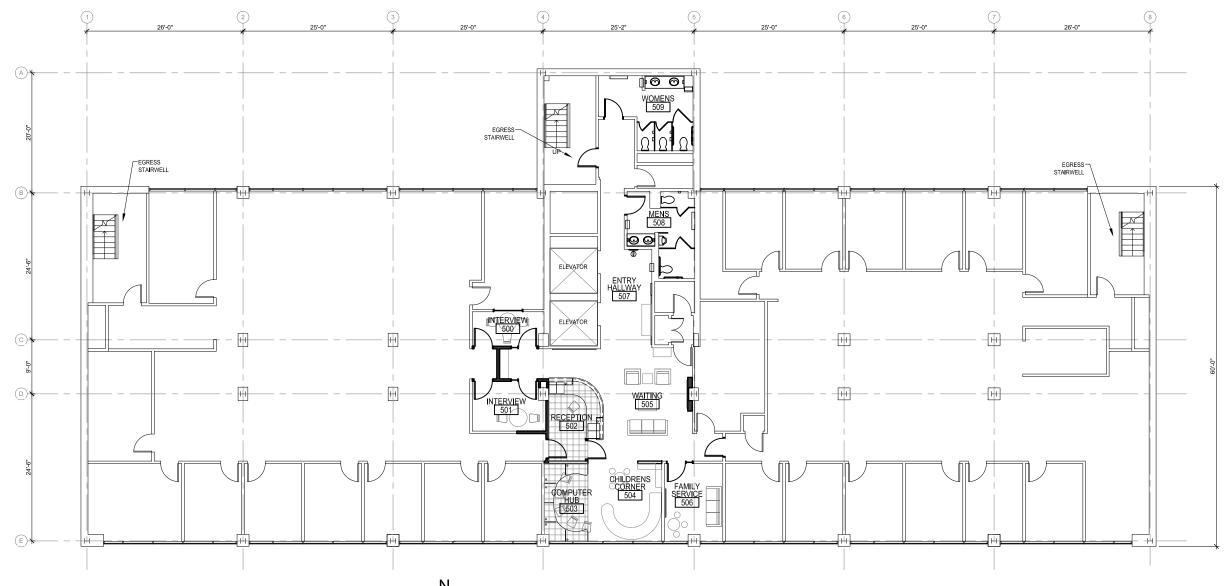
DOCUMENTS FOR CONSTRUCTION

15 OCTOBER 2015

Stantec Project Number: 2046049200

#### ATTACHMENT A

SHEET INDEX						
SHEET NUMBER	SHEET TITLE					
G-001	COVER SHEET, DRAWING INDEX					
A-100	FIRE CODE REVIEW — RENOVATION					
A-101	DEMOLITION - FLOOR & CEILING PLANS					
A-102	RENOVATION FLOOR PLAN					
A-103	N.T.S RENOVATION CEILING PLAN					
A-104	ALTERNATE RESTROOM PLAN					
A-105	ROOM FINISH SCHEDULE, SIGNAGE SCHEDULE & MATERIAL FINISH LEGEND					
A-106	FLOORING PATTERN					
A-107	DOOR & HARDWARE SCHEDULES, DOOR/FRAME TYPES					
A-401	INTERIOR ELEVATIONS					
A-402	INTERIOR ELEVATIONS					
A-501	DETAILS					
A-502	RECEPTION DESK DETAILS					
M-101	DEMOLITION PLANS-FLOOR & CEILING					
M-102	RENOVATION—FLOOR PLAN					
M-103	RENOVATION—CEILING PLAN					
E-001	ELECTRICAL LEGEND, ABBREVIATIONS & SCHEDULES					
E-101	LIGHTING PLAN - DEMOLITION					
E-102	LIGHTING PLAN - NEW					
E-103	POWER PLAN - DEMOLITION					
E-104	POWER PLAN - NEW					
E-105	SYSTEMS PLAN - DEMOLITION					
E-106	SYSTEMS PLAN - NEW					
E-201	ELECTRICAL ONE-LINE DIAGRAM & PANEL SCHEDULE					
E-301	ELECTRICAL SPECIFICATIONS					





#### FIRE AND BUILDING CODE REVIEW

2009 INTERNATIONAL EXISTING BUILDING CODE (IEBC) 2009 INTERNATIONAL BUILDING CODE (IBC)

PROJECT DESCRIPTION:
TENANT IMPROVEMENT FOR 5TH FLOOR LOBBY & RESTROOMS OF AN EXISTING OFFICE BUILDING. OFFICE BUILDING LOCATED AT 122 1ST AVE., FAIRBANKS, AK. 99701. 5TH FLOOR RENOVATION IS 1,888 SQ FT.

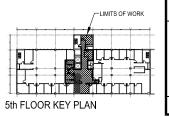
CLASSIFICATION OF WORK: LEVEL 2 ALTERATION
"LEVEL 2 ALTERATIONS INCLUDE THE RECONFIGURATION OF SPACE, THE ADDITION OR ELIMINATION OF ANY DOOR OR WINDOW,
THE RECONFIGURATION OR EXTENSION OF ANY SYSTEM, OR THE INSTALLATION OF ANY ADDITIONAL EQUIPMENT."

## OCCUPANCY CLASSIFICATION B, BUSINESS

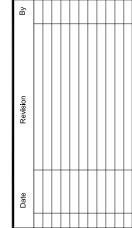
FIRE SYSTEM FULLY SPRINKLERED

## GROUND ACCELERATION SUB S = 1.09

OCCUPANCY CATAGORY 2









2515 'A' Street Anchorage, Alaska 99503 (907) 276-4245 544 4th Avenue, Suite 102 Falrbanks, Alaska 99701 (907) 452-2128

3017 Clinton Drive Sulte 201 Juneau, Alaska 99801 (907) 790-2901

351 W. Parks Highway Suite 200 Wasllla, Alaska 99654 (907) 376-7815


CHIEF PETER JOHN TRIBAL BUILDING

5TH FLOOR LOBBY RENOVATION

Project No. 01124 08278 00258 TANANA CHIEFS CONFERENCE 122 1ST AVENUE FAIRBANKS, AK 99701

Project Mgr.	VANDEF	RWEEL
Drawn	maf	
Checked	JC	
Date	10/15	/2015
Chaot Contonto		

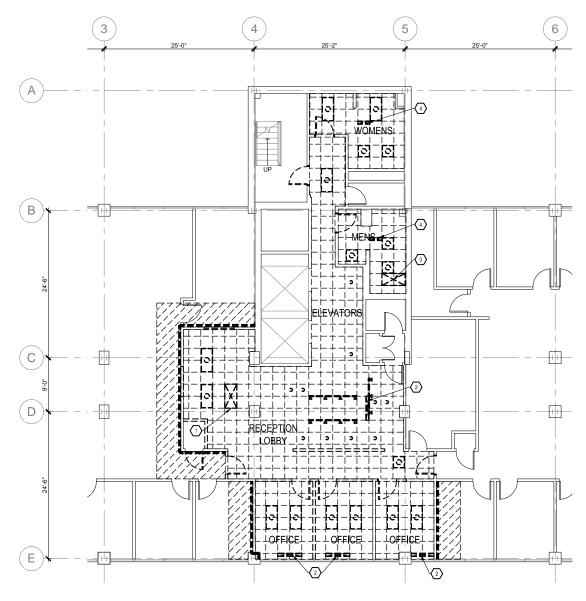FIRE CODE **REVIEW -**RENOVATION





# 2 CEILING PLAN - DEMOLITION SCALE: 1/8'=1'.0'

CEILING PLAN DEMOLITION LEGEND:
-EXISTING TO REMAIN UNLESS OTHERWISE NOTED-

-EXISTING SPRINKLER SYSTEM WILL REQUIRE MODIFICATION-

EMPTY REMOVE SUSPENDED 24"x24" SUSPENDED
I I I I ACOUSTIC TILE CEILING ASSEMBLY
PANELS & GRID SYSTEM)

FT OR TEMOVE LIGHT FIXTURES

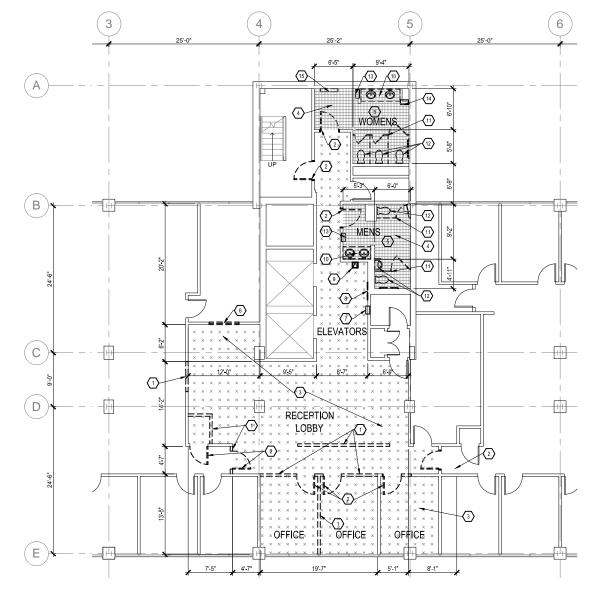
REMOVE DIFFUSERS

REMOVE & SALVAGE EXISTING
SUSPENDED CEILING ASSEMBLY AS REQ'D
TO PERFORM NEW WORK WALL TOP
EXTENSION. REINSTALL ASSEMBLY AFTER
COMPLETION OF NEW WORK

PREP EXISTING WALL FOR TOP HEIGHT EXTENSION

#### CEILING PLAN DEMOLITION NOTES:

- REMOVE 24X48 R/A GRILLE & PREP FOR REINSTALLATION IN NEW CEILING GRID.
- 2 REMOVE & PREP CEILING SUPPLY AIR SLOT DIFFUSER FOR REINSTALLATION IN NEW CEILING GRID.
- DEMOLISH EXISTING FAN-POWERED VAV BOX THAT IS BLOWING PLENUM AIR INTO TOILET ROOMS & JANITOR CLOSET.
- MODIFY EXHAUST AIR GRILLES IN TOILET ROOMS & JANITOR CLOSET FOR FULL-FACED EXHAUST. RELOCATE EXISTING GRILLE AS NECESSARY TO FIT INTO NEW CEILING GRID.





# 1

#### FLOOR PLAN - DEMOLITION

SCALE: 1/8"=1'-0"

FLOOR PLAN DEMOLITION NOTES:
-EXISTING TO REMAIN UNLESS OTHERWISE NOTED-

-EXISTING TO REMAIN UNLESS OTHERWISE NOT -PREP EXISTING SURFACES FOR NEW WORK-

REMOVE WALL ENTIRELY
 REMOVE DOOR ASSEMBLY (DR, FRAME, HDWR)
 REMOVE CARPETING & WALL BASE
 REMOVE CERAMIC TILE FLOORING

TREMOVE EXISTING CERAMIC WALL TILE & SUBSTRATE (ENTIRE ROOM) TO EXPOSE EXISTING STUDS TO REMAIN

REMOVE PASS-THROUGH WINDOW
 REMOVE FEC - SALVAGE FOR REUSE
 REMOVE WALL PLAQUE - HAND OVER TO OWNER
 REMOVE DRINKING FOUNTAIN - PREP PLUMBING

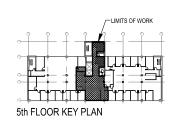
FOR NEW FIXTURE

(10) REMOVE SINKS & COUNTER INCLUDING WALL
MIRROR & SOAP DISPENSERS

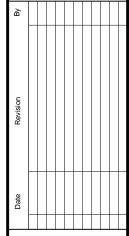
REMOVE TOILET PARTITIONS & ACCESSORIES
REMOVE TOILET FIXTURES
REMOVE PTDWR (RECESSED) - SALVAGE FOR

REUSE

(14) REMOVE SN DISPENSER - SALVAGE FOR REUSE
(15) REMOVE CHANGING TABLE









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351 W. Parks Highway Suite 200 Wasilla, Alaska 99654 (907) 376-7815

www.stante

CHIEF PETER JOHN
TRIBAL BUILDING

5TH FLOOR LOBBY RENOVATION

Project No. 01124 08278 002584
TANANA CHIEFS CONFERENCE
122 1ST AVENUE
FAIRBANKS, AK 99701

Project Mgr.	VANDERWE			
Drawn	maf			
Checked	JC			
Date	10/15	/2015		

Sheet Contents:

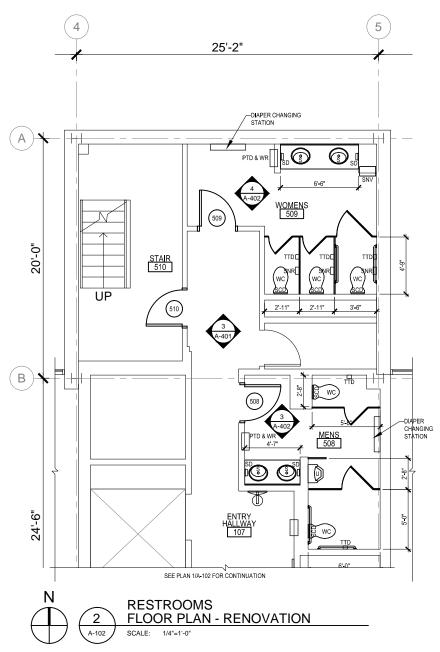
DEMOLITION PLANS -FLOOR & CEILING

Sheet No.:

A-101

STANTEC W.O. 2046049200

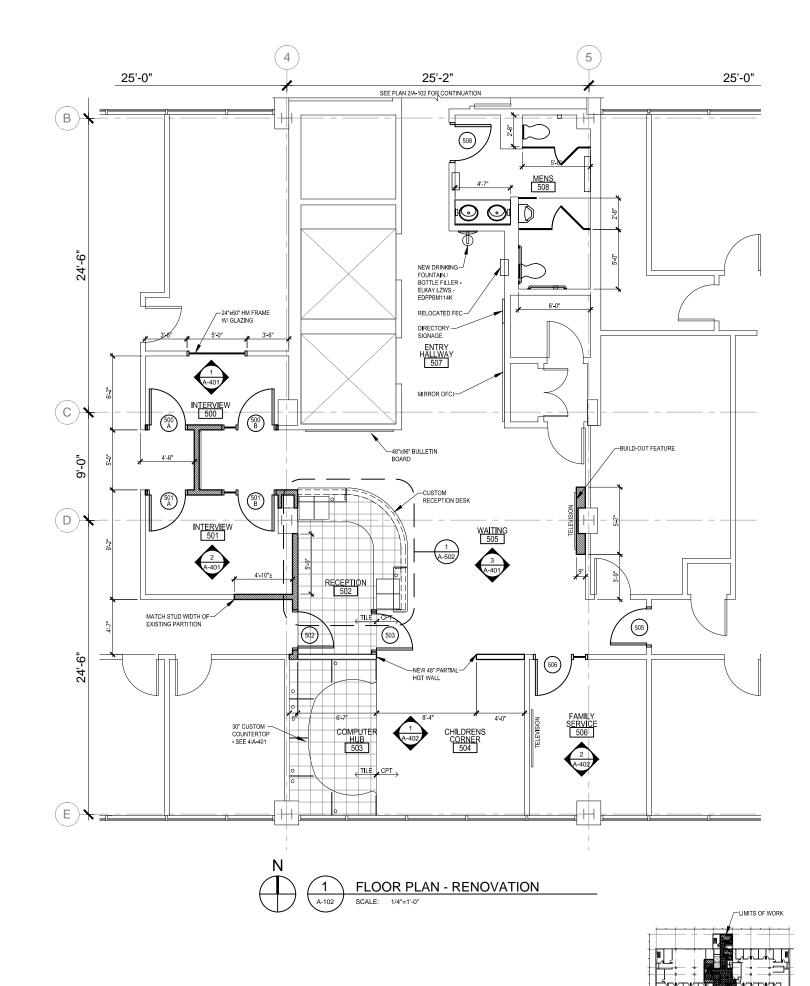
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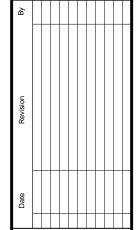
#### FLOOR PLAN LEGEND

EXISTING PARTITION TO
REMAIN. AS-BUILTS INDICATE
STUDS ARE 2-1/2" METAL.
SPACING ASSUMED @ 24"O.C.
(FIELD VERIFY) W/ 5/8" GYPSUM
BD EACH SIDE.

NEW PARTITION. 4" METAL STUD @ 24"O.C. W/ 5/8" GYPSUM BD EA SIDE. PROVIDE ACOUSTIC SEALANT AT WALL
PERIMETER, NOTE - MATCH
STUD WIDTH OF EXISTING WALL WHERE INDICATED.









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351 W. Parks Highway Suite 200 Wasilla, Alaska 99654 (907) 376-7815

CHIEF PETER JOHN TRIBAL BUILDING

**5TH FLOOR LOBBY** RENOVATION

Project No. 01124 08278 002584 TANANA CHIEFS CONFERENCE 122 1ST AVENUE FAIRBANKS, AK 99701


Project Mgr.	VANDERWE						
Drawn	maf						
Checked	JC						
Date	10/15	/2015					


Sheet Contents: **RENOVATION -**FLOOR PLAN

A-102


STANTEC W.O. 2046049200

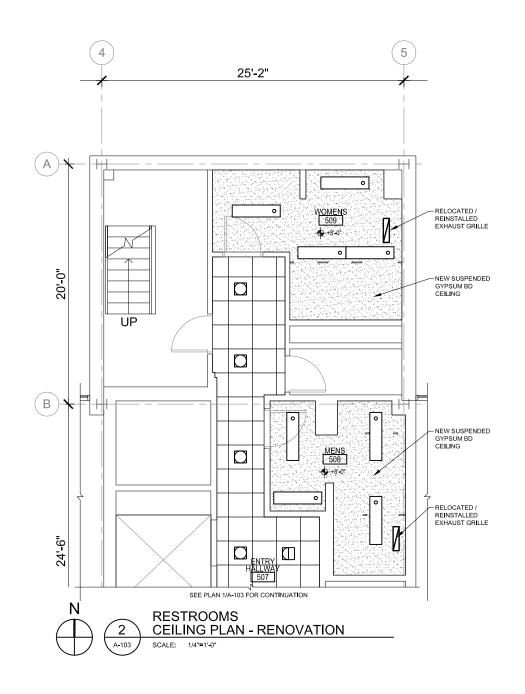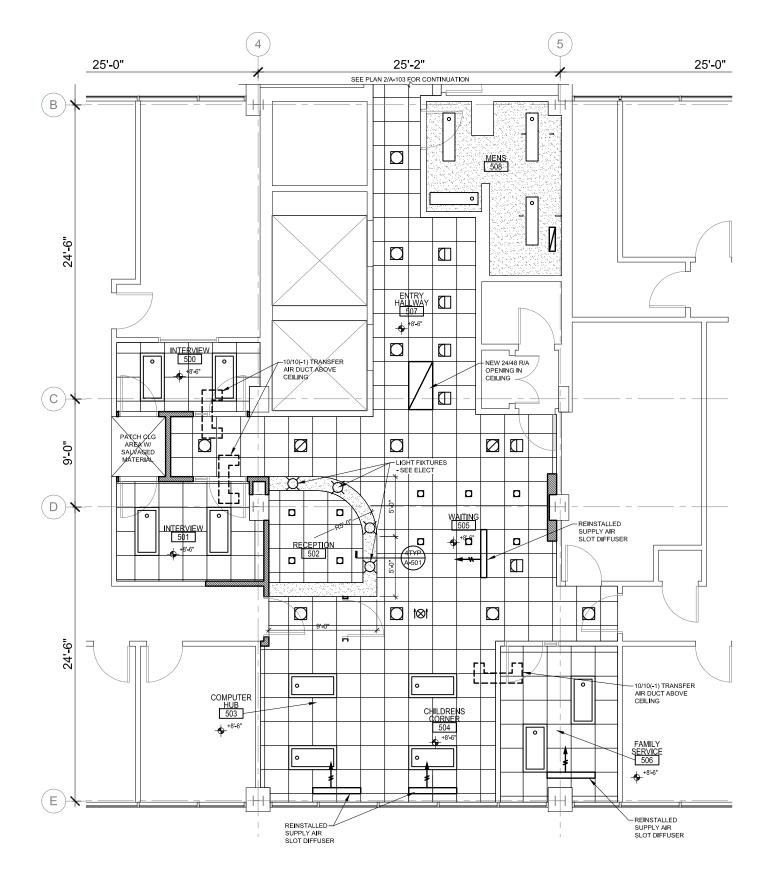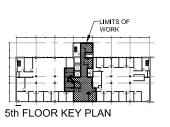Sheet No.:

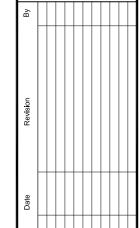














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CHIEF PETER JOHN TRIBAL BUILDING

5TH FLOOR LOBBY RENOVATION

Project No. 01124 08278 002584

TANANA CHIEFS CONFERENCE
122 1ST AVENUE
FAIRBANKS, AK 99701

Project Mgr.	VANDERWEE			
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Checked	JC			
Date	10/15	/2015		
Sheet Contents	:			


RENOVATION -CEILING PLAN PLAN


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A-103


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Project: CHIEF PETER JOHN TRIBAL BUILDING

**5TH FLOOR LOBBY** RENOVATION

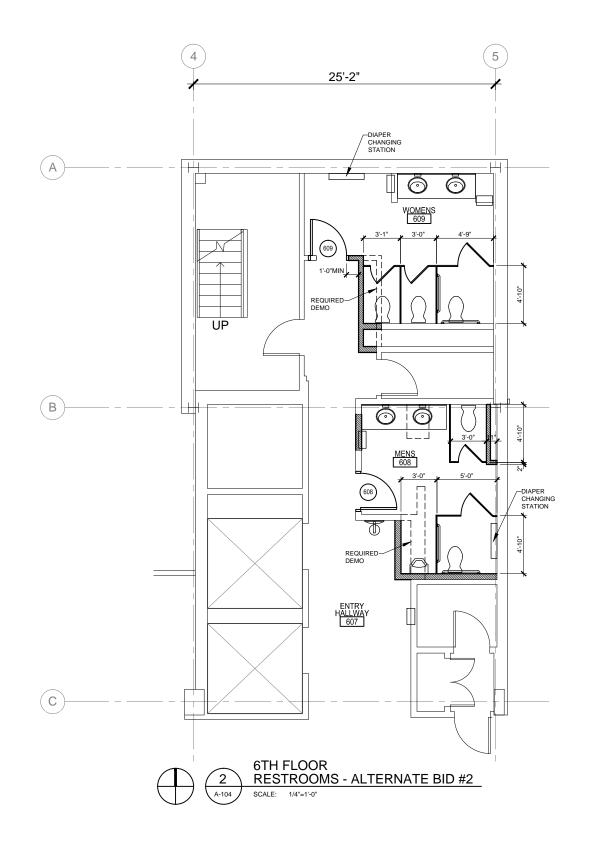Project No. 01124 08278 002584 TANANA CHIEFS CONFERENCE 122 1ST AVENUE FAIRBANKS, AK 99701

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Checked	JC				
Date	10/15	/2015			

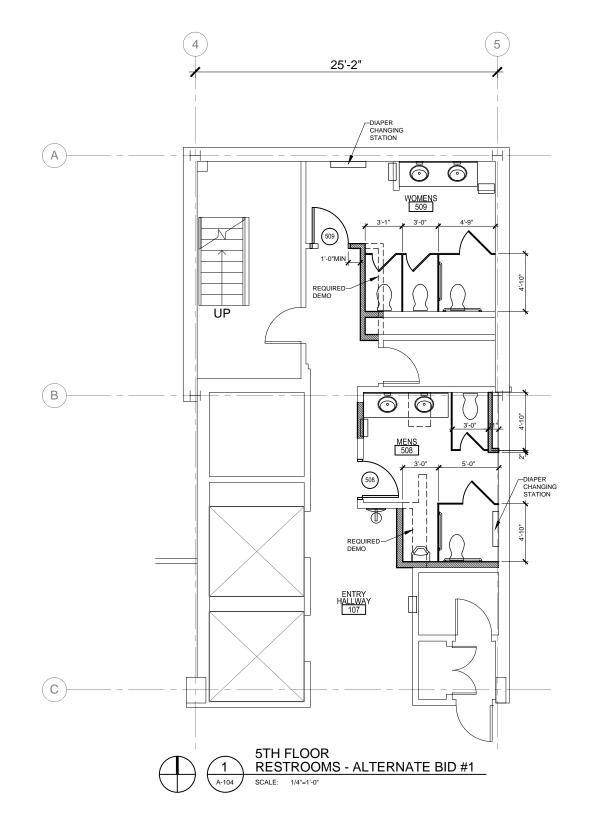Sheet Contents:

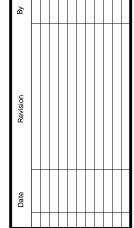ALTERNATE RESTROOM PLAN

A-104

		MATERIA	L FINISH	LECEND	
		IVIATEINIA	L I IIVISII	LLGLIND	
ITEM	DESCRIPTION	MANUFACTURER	SERIES	COLOR/PATTERN	NOTES
ACT-1	SUSPENDED ACOUSTIC CEILING	ARMSTRONG	ULTIMA, VECTOR	#1920, WHITE, 2'x2'x15/16"	
C-1	NOT USED	-	-	-	-
CPT-1	CARPET TILE	INTERFACE	HUMAN NATURE	HN 840, #104225, PUMICE	25 CM X 100 CM PLANK ASHLAR INSTALL SEE A-106
CPT-2	CARPET TILE	INTERFACE	HUMAN NATURE	HN 850, #104209, PUMICE	25 CM X 100 CM PLANK ASHLAR INSTALL SEE A-106
CPT-3	CARPET TILE	INTERFACE	HUMAN NATURE	HN 810, #104217, PUMICE	25 CM X 100 CM PLANK ASHLAR INSTALL SEE A-106
CPT-4	CARPET TILE	INTERFACE	HUMAN NATURE	HN 830, #104242, KIWI	25 CM X 100 CM PLANK ASHLAR INSTALL SEE A-106
CW-1	CASEWORK	FORMICA	LAMINATE	NATURAL BIRCH #7481-58	FRONT PANELS OF RECEPTION DESK
CW-2	CASEWORK	FORMICA	LAMINATE	GRAPHITE 3837-58	BASE COLOR OF RECEPTION DESK
DR-1	DOOR RELITES	3 FORM	RESIN PANEL	BEAR GRASS 50% FADE	
P-1	INTERIOR WALL PAINT	SHERWIN WILLIAMS	EGGSHEL/SATIN	KILIM BEIGE, SW 6106	
P-2	CEILING SOFFIT PAINT	SHERWIN WILLIAMS	EGGSHEL/SATIN	REFLECTING POOL, SW 6486	
P-3	INTERIOR ACCENT WALL PAINT	SHERWIN WILLIAMS	EGGSHEL/SATIN	GRAND CANAL, SW 6488	
P-4	HM DOOR FRAME PAINT	SHERWIN WILLIAMS	SEMI GLOSS	NOMADIC DESERT, SW 6107	
RB-1	RUBBER WALL BASE	ROPPE	PINNACLE, TYPE TS	#194, BURNT UMBER	4" BASE
SS-1	SOILD SURFACE COUNTERTOP	AVONITE	STUDIO COLLECTION	K3-8345, SILVER PEARL	RECEPTION COUNTER TOP
SS-2	SOILD SURFACE COUNTERTOP	AVONITE	STUDIO COLLECTION	K3-8343, PEARL	
RS-1	ROLLER SHADES	MECHOSYSTEM	MECHO/5 WIDE BRACKET W/ FASCIA	THERMOVEIL SHADE, BASKET WEAVE, 1300 SERIES	ARCHITECT TO SELECT COLOR
T-1	FLOOR TILE	DAL TILE	FABRIQUE	GRIS LINEN, P690	UN POLISHED 12X12
T-2	WALL TILE	DAL TILE	FABRIQUE	CREME LINEN, P686	LIGHT POLISHED 12X24, 48" HIGH WAINSCOT
T-3	WALL TILE - BULL NOSE	DAL TILE	FABRIQUE	CREME LINEN, S-43C9	LIGHT POLISHED 3X12 ON TOP OF WAINSCOT
TP	TOILET PARTITIONS	ASI GLOBAL PARTITIONS	STAINLESS STEEL	LEATHER FINISH	

	ROOM FINISH SCHEDULE  ROOM # ROOM NAME FLOOR BASE NORTH WALL EAST WALL SOUTH WEST WALL DOOR FRAME FINISH MILLWORK COMMENTS  500 INTERVIEW CPT-3 RB-1 P-1 P-1 P-1 P-1 P-4 ACT-1											
ROOM#	ROOM NAME	FLOOR	BASE	NORTH WALL	EAST WALL	SOUTH	WEST WALL	DOOR FRAME	CEILING FINISH	MILLWORK	COMMENTS	
500	INTERVIEW	CPT-3	RB-1	P-1	P-1	P-1	P-1	P-4	ACT-1			
501	INTERVIEW	CPT-3	RB-1	P-1	P-1	P-1	P-1	P-4	ACT-1			1
502	RECEPTION	T-1	RB-1	P-1	-	P-1	P-3	P-4	P-2 / ACT-1	SS-1 COUNTER TOP / CW-2 BASE W/ CW-1 ACCENT PANELS		à
503	COMPUTER HUB	T-1	RB-1	P-1	-	P-1	P-1	P-4	ACT-1	SS-1 COUNTER TOP & BACKSPLASH	RS-1	1
504	CHILDREN'S CORNER	CPT-4	RB-1	P-1	P-1	P-1	-	P-4	P-2 / ACT-1		GWB SOFFIT CEILING TO BE PAINTED P-2, RS-1	
505	WAITING	CPT-1 / CPT-2 / CPT-3	RB-1	P-1	P-1 / ST-1/P-3	P-1	P-1/P-3	P-4	ACT-1		BASE OF STONE VENEER TO BE RB-2. WALL BEHIND 502 TO BE PAINTED P-3.	Pavision
506	FAMILY SERVICES	CPT-3	RB-1	P-1	P-1	P-1	P-1	P-4	ACT-1		RS-1	
507	ENTRY	CPT-1 / CPT-2	RB-1	P-1	P-1	-	P-1	P-4	ACT-1			
508	MEN'S RESTROOM	T-1	T-2	T-2 / T-3 / P-1	P-4	P-1	SS-2 COUNTER TOP & BACKSPLASH	PROVIDE NEW TOILET PARTITIONS	Ę ą			
509	WOMEN'S RESTROOM	T-1	T-2	T-2 / T-3 / P-1	T-2/T-3/P-1	T-2/T-3/P-1	T-2/T-3/P-1	P-4	P-1	SS-2 COUNTER TOP & BACKSPLASH	PROVIDE NEW TOILET PARTITIONS	₽



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Project:
CHIEF PETER JOHN

TRIBAL BUILDING
5TH FLOOR LOBBY

RENOVATION

Project No. 01124 08278 002584 TANANA CHIEFS CONFERENCE 122 1ST AVENUE FAIRBANKS, AK 99701

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Date	10/15	/2015		

Sheet Contents:

ROOM FINISH SCHEDULE -MATERIAL FINISH LEGEND

Sheet No.:

A-105

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ROOM SIGN SCHEDULE APCO, ELEMENTS 2, ARC-AR1, L02 COASTAL GRASS ROOM# ROOM NAME NOTES 500 INTERVIEW PROVIDE BRAILLE INTERVIEW 501 PROVIDE BRAILLE FAMILY SERVICES PROVIDE BRAILLE 506 6" VERTICAL PICTORGRAM W/ ROOM NAME & BRAILLE BELOW 508 6" VERTICAL PICTORGRAM W/ ROOM NAME & BRAILLE BELOW 509 WOMEN

CHANGING EXTATION, HORIZONTAL STAINLESS STEEL WALL MOUNTED, MODEL # KB-110-SSWM

INTERIOR ROOM SIGNAGE TO BE APCO, ELEMENTS 2, ARC-AR1, LO2 COASTAL

**5** 

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CUSTOM DESIGN LAYOUT PLANK ASHLAR INSTALL SEE FINISH SCHEDULE ON A-105 FOR CARPET INFORMATION



CPT-1



CPT-2



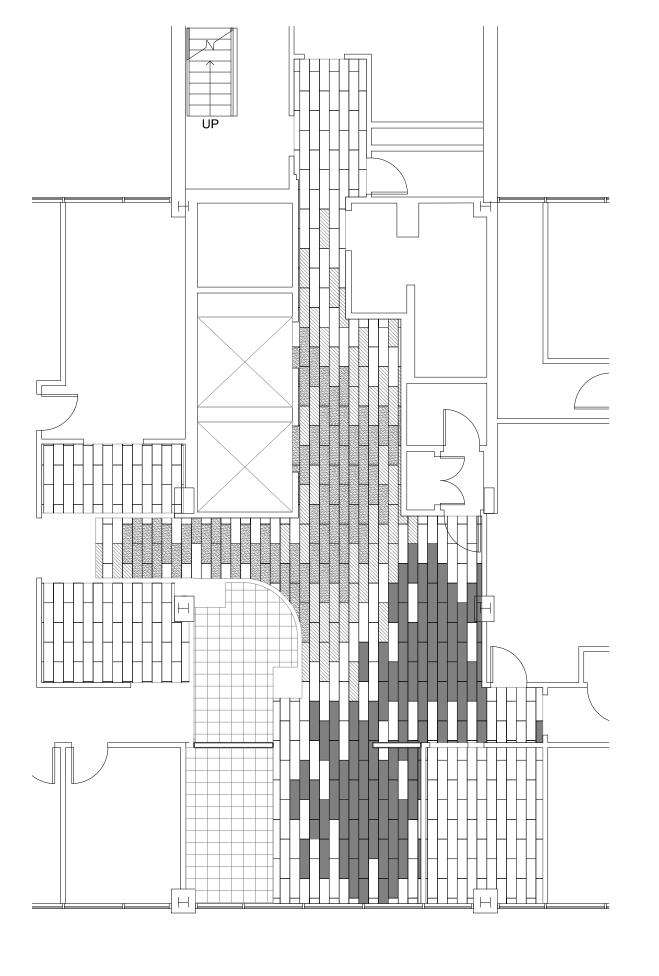
CPT-3



CPT-4



T-1











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5TH FLOOR LOBBY RENOVATION

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Date	10/15	/2015

Sheet Contents:

FLOORING PATTERN

Sheet No.:


A-106

## DOOR HARDWARE SCHEDULE

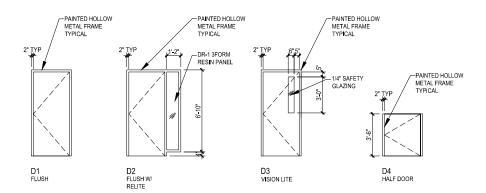
HW 9 3 1 1 1 1 1 1	01 EA EA EA EA EA EA	HINGE VANDL CLASSROOM LOCK PERMANENT CORE SURFACE CLOSER KICK PLATE WALL STOP GASKETING	5BB 1 4.5 X 4.5 ND94HD SPA BY OWNER 4040XP TBWMS 8400 10" X 2" LDW WS401CCV 188S-BK	652 626 689 630 626 S-Bk	IVE SCH BES LCN IVE IVE ZER
HW 9 3 1 1 1 1 1	02 EA EA EA EA EA EA	HINGE VANDL CLASSROOM LOCK PERMANENT CORE OH STOP SURFACE CLOSER KICK PLATE GASKETING	5BB1 4.5 X 4.5 ND94HD SPA BY OWNER 90S 4040XP TBWMS 8400 10" X 2" LDW 188S-BK	652 626 630 689 630 S-Bk	IVE SCH BES GLY LCN IVE ZER
HW 9 3 1 1 1 1 1	03 EA EA EA EA EA EA	HINGE PUSH PLATE PULL PLATE SURFACE CLOSER KICK PLATE WALL STOP SILENCER	5BB1 4.5 X 4.5 8200 4" X 16" 8302 8" 4" X 16" 4040XP TBWMS 8400 10" X 2" LDW WS401CCV SR64	652 630 630 689 630 626 GRY	IVE IVE IVE LCN IVE IVE
HW 9 2 1 2	04 EA EA EA	SPRING HINGE PASSAGE SET SILENCER	3SP1 4.5 X 4.5652 ND10S SPA SR64	626 GRY	IVE SCH IVE
HW 9 3 1 1 1 1 1	05 EA EA EA EA EA EA	HINGE VANDL STOREROOM LOCK PERMANENT CORE SURFACE CLOSER KICK PLATE WALL STOP GASKETING	5BB1 4.5 X 4.5 NRP ND96HD SPA BY OWNER 4040XP EDA TBWMS 8400 10" X 2" LDW WS401CCV 188S-BK	652 626 689 630 626 S-Bk	IVE SCH BES LCN IVE IVE ZER
HW 9 3 1 1 1 1 1	EA EA EA EA EA EA	HINGE PASSAGE SET SURFACE CLOSER KICK PLATE WALL STOP GASKETING	5BB1 4.5 X 4.5 ND10S SPA 4040XP EDA TBWMS 8400 10" X 2" LDW WS401CCV 188S-BK	652 626 689 630 626 S-Bk	IVE SCH LCN IVE IVE ZER

	DOOR SCHEDULE						
DOOR NUMBER	TYPE	SIZE	MATERIAL	HW SET#	COMMENTS		
500A	D3	3'-0" x 7'-0" x 1 <sup>3</sup> / <sub>4</sub> "	SCWD	01			
500B	D2	3'-0" x 7'-0" x 1 <sup>3</sup> / <sub>4</sub> "	SCWD	02			
501A	D3	3'-0" x 7'-0" x 1 <sup>3</sup> / <sub>4</sub> "	SCWD	01			
501B	D2	3'-0" x 7'-0" x 1 <sup>3</sup> / <sub>4</sub> "	SCWD	01			
502	D3	3'-0" x 7'-0" x 1 <sup>3</sup> / <sub>4</sub> "	SCWD	05			
503	D4	3'-0" x 3'-6" x 1 <sup>3</sup> / <sub>4</sub> "	SCWD	04			
505	D3	3'-0" x 7'-0" x 1 <sup>3</sup> / <sub>4</sub> "	SCWD	05			
506	D2	3'-0" x 7'-0" x 1 <sup>3</sup> / <sub>4</sub> "	SCWD	01			
508	D1	3'-0" x 7'-0" x 1 <sup>3</sup> / <sub>4</sub> "	SCWD	03	UNDERCUT 3/4"		
509	D1	3'-0" x 7'-0" x 1 <sup>3</sup> / <sub>4</sub> "	SCWD	03	UNDERCUT 3/4"		
510	D1	3'-0" x 7'-0" x 1 <sup>3</sup> / <sub>4</sub> "	НМ	06			

ABBREVAITIONS:
SCWD SOLID-CORE WOOD
HM HOLLOW METAL



## DOOR / FRAME TYPES

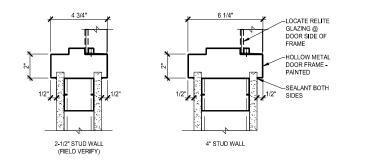







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5TH FLOOR LOBBY RENOVATION

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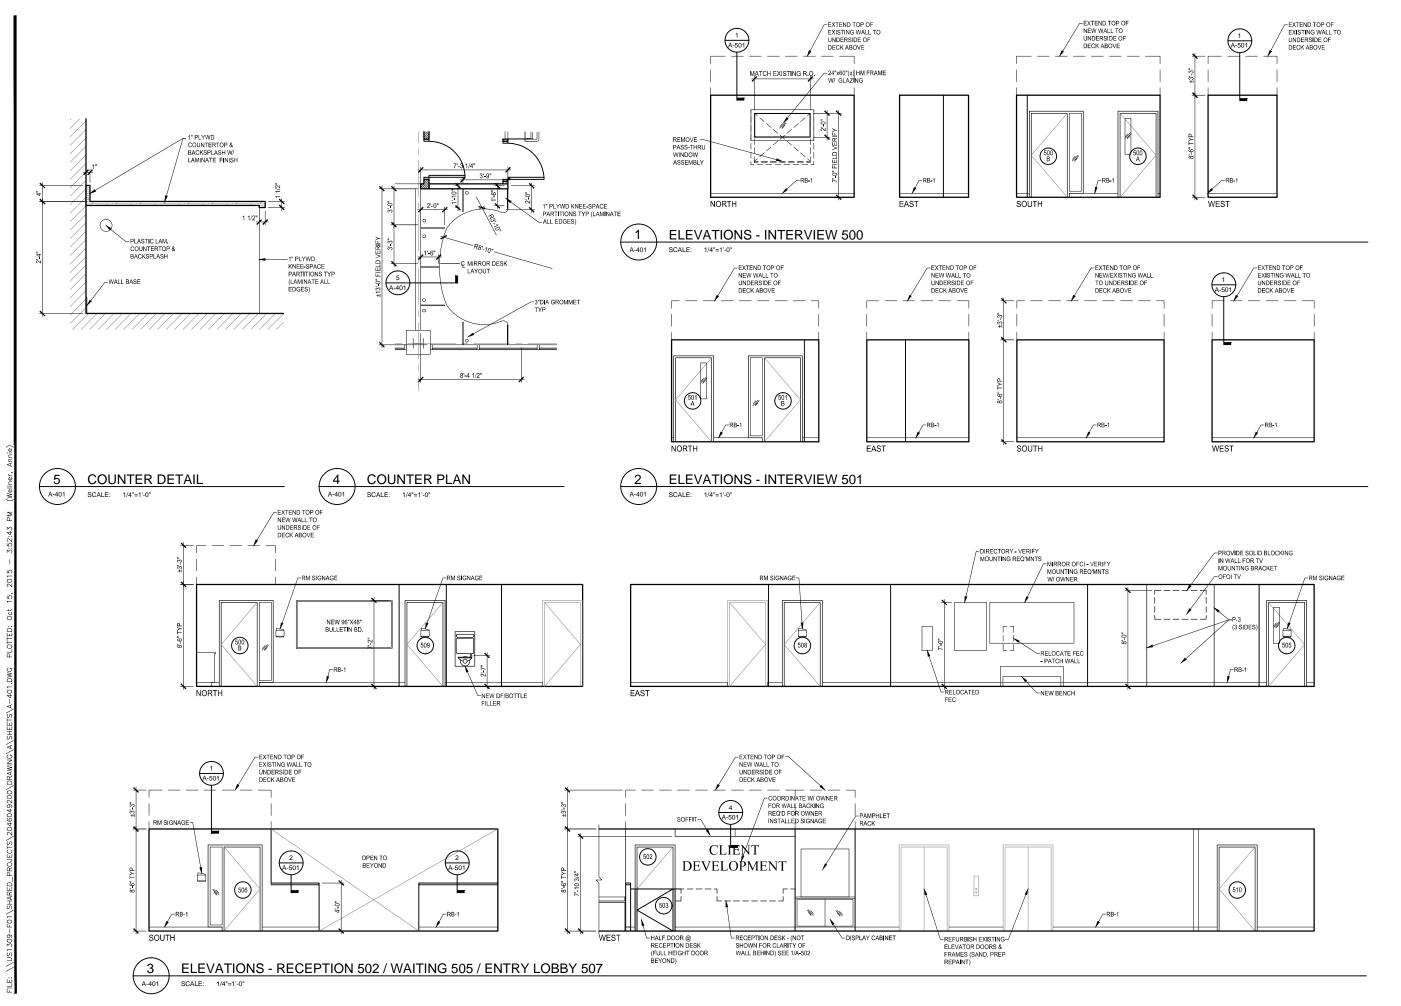
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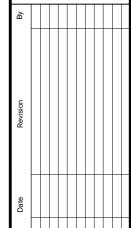
DOOR SCHEDULE, DOOR / FRAME TYPES

Sheet No.:

A-107









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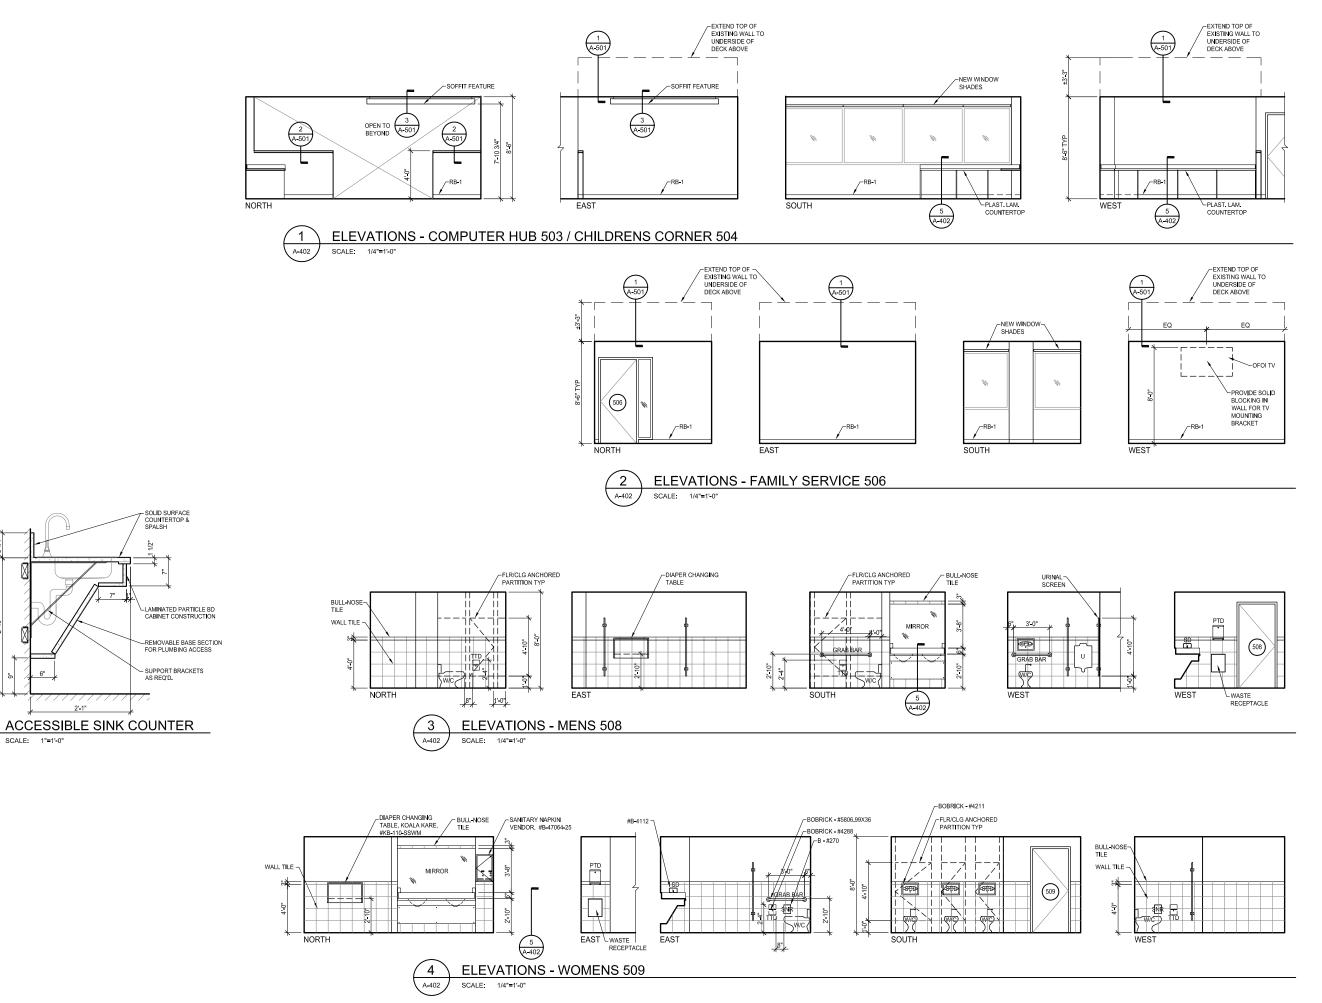
ELEVATIONS

Sheet No.:

A-401

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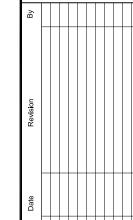
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BLOCKING IN

A-402

Jared T. VanderWeele No. 12885





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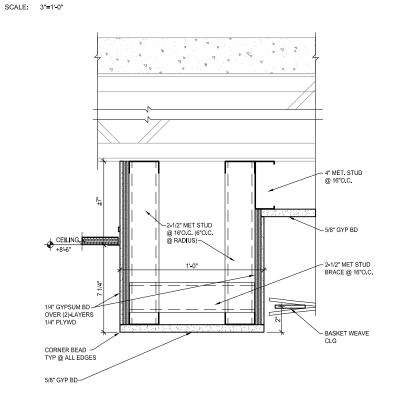
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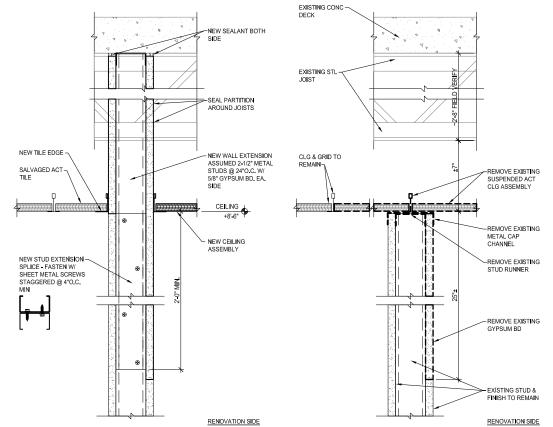
Sheet No.:

A-402




#### NOT USED





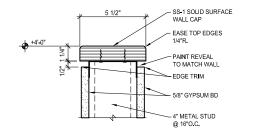WALL EXTENSION DETAIL











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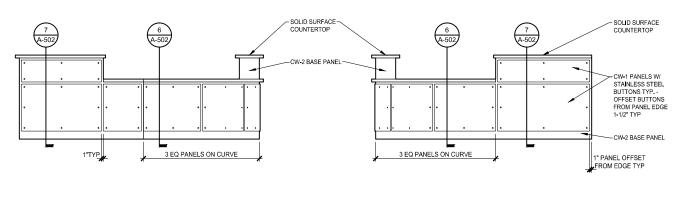
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Checked	JC			
Date	10/15/2015			
Sheet Contents:				

DETAILS

A-501

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SOFFIT DETAIL

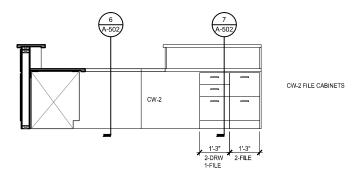


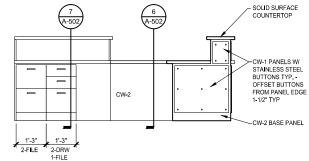
**DESK ELEVATION** A-502 SCALE: 1/2"=1'-0"

SCALE: 1/2"=1'-0"

A-502


**DESK ELEVATION** A-502 SCALE: 1/2"=1'-0"







DESK ELEVATION



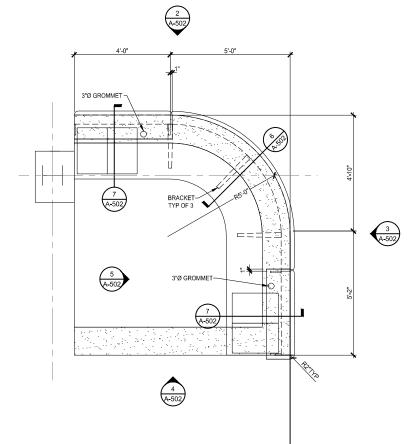

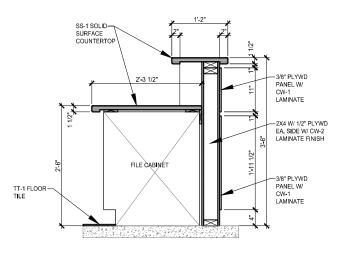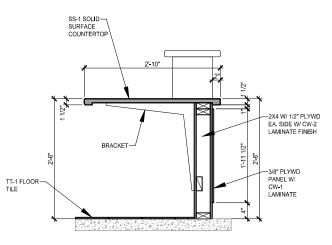RECEPTION DESK ENLARGED PLAN A-502 SCALE: 1/2"=1'-0"

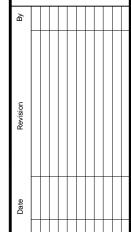














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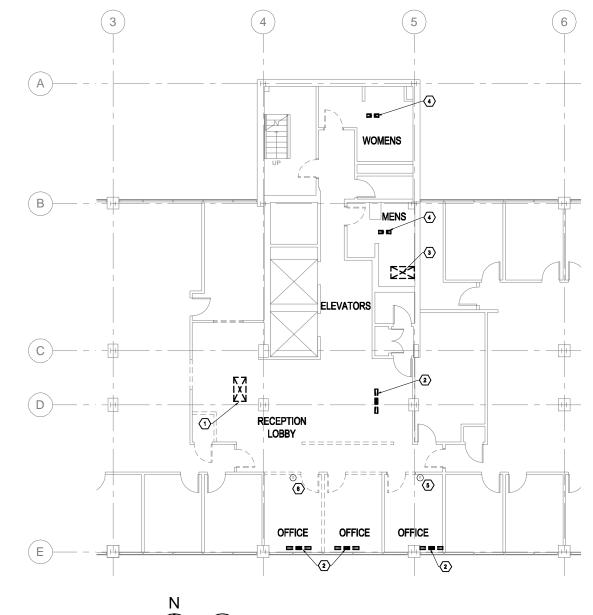
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Date	10/15	/2015				

Sheet Contents:

RECEPTION DESK DETAILS

Sheet No.:

A-502

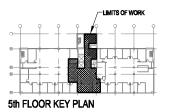


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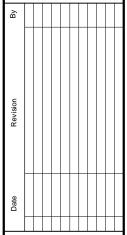
PLAN - DEMOLITION

- DEMOLITION NOTES:

  REMOVE 24X48 R/A GRILLE & CLEANED FOR REINSTALLATION IN NEW CEILING GRID.
- (2) REMOVE & CLEAN CEILING SUPPLY AIR SLOT DIFFUSER FOR REINSTALLATION IN NEW CEILING GRID.
- (3) DEMOLISH EXISTING FAN-POWERED VAV BOX AND DUCTWORK THAT IS BLOWING PLENUM AIR INTO TOILET ROOMS & JANITOR CLOSET.
- (4) MODIFY EXHAUST AIR GRILLES IN TOILET ROOMS & JANITOR CLOSET FOR FULL-FACED EXHAUST. RELOCATE EXISTING GRILLE AS NECESSARY TO FIT INTO NEW CEILING PER NEW CONSTRUCTION
- 5 EXISTING ROOM SENSOR TO REMAIN.
- (8) EXISTING ROOM SENSOR SHALL BE RELOCATED TO NEAREST, NON-EXTERIOR WALL THAT IS TO REMAIN.









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**CHIEF PETER JOHN** TRIBAL BUILDING

**5TH FLOOR LOBBY** RENOVATION


Project No. 01124 08278 00258 TANANA CHIEFS CONFERENCE 122 1ST AVENUE FAIRBANKS, AK 99701

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Checked	JC			
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Sheet Contents:				

DEMOLITION PLANS -FLOOR & CEILING

Sheet No.:

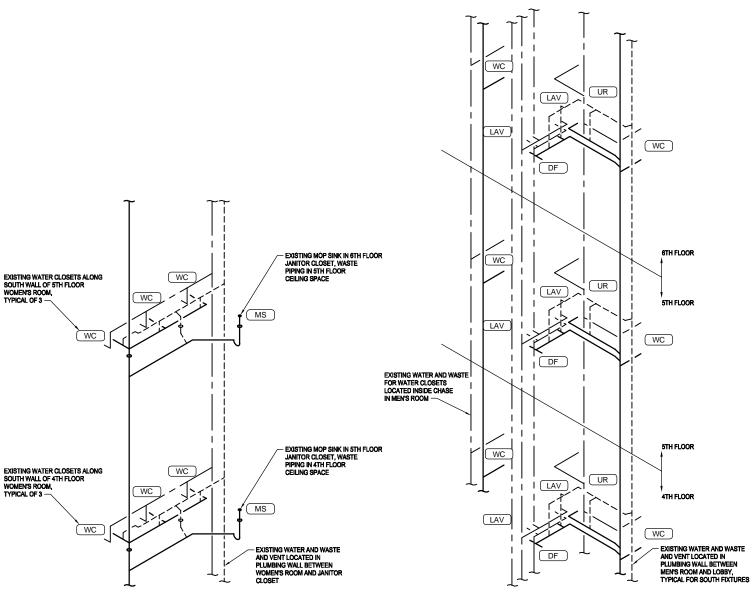M-101



NOTE: RISERS SHOWN FOR TO INFORM CONTRACTOR OF GENERAL EXISTING PIPING ARRANGEMENT. MINOR MODIFICATIONS SHALL BE NECESSARY FOR NEW FIXTURE INSTALLATION, HOWEVER PIPING SHALL REMAIN IN THIS GENERAL CONFIGURATION.

WOMEN'S ROOM **EXISTING PLUMBING RISER** M-102



FIFTH FLOOR -**PARTIAL PLAN - RENOVATION** NOTE: RISERS SHOWN FOR TO INFORM CONTRACTOR OF GENERAL EXISTING PIPING ARRANGEMENT. MINOR MODIFICATIONS SHALL BE NECESSARY FOR NEW FIXTURE INSTALLATION, HOWEVER PIPING SHALL REMAIN IN THIS GENERAL CONFIGURATION. SCALE: 1/4"=1'-0"

( A

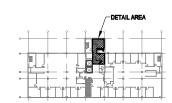
(B)

FLOOR PLAN NEW WORK NOTES: INSTALL NEW WATER CLOSET, CONNECT TO EXISTING WASTE AND VENT PIPING.

UP

(2) INSTALL NEW URINAL, CONNECT TO EXISTING WASTE AND VENT PIPING.

- ③ INSTALL NEW LAVATORY, CONNECT TO EXISTING WASTE AND VENT PIPING.
- 4 UP TO EXISTING MOP SINK IN 6TH FLOOR JANITOR CLOSET, MAINTAIN AS-IS.
- (5) WASTE FROM EXISTING FLOOR DRAIN IN 6TH FLOOR MEN'S ROOM, MAINTAIN AS-IS.



5th FLOOR KEY PLAN

(3) (AV-1)

WC-1

**①** 

**(1)** 

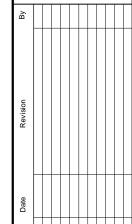
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DF-1

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PLUM	PLUMBING FIXTURE CONNECTION SCHEDULE												
			TRAP	WASTE	VENT			FIXTURE - DESIGN BASIS PRO	DUCT	FAUCET/VALVE - I	DESIGN BASIS PRODUCT		
TAG	FIXTURE	MOUNTING	(IN)	(IN)	(IN)	(IN)	MFR.	MODEL	MATERIAL	MFR.	MODEL	NOTES	TAG
WC-1	ADA WATER CLOSET	WALL	-	4	2	1/2	AMER. STD.	3351001	VITREOUS CHINA	SLOAN	OPTIMA 111-1.28	1.28 GPF, ELONGATED BOWL, ADA HEIGHT, EVERCLEAN SURFACE, PROVIDE WITH SEAT, BASIS OF DESIGN IS AMERICAN STANDARD 5905110.	
WC-2	ADA WATER CLOSET	FLOOR	-	4	2	1/2	AMER. STD.	3462001	VITREOUS CHINA	SLOAN	OPTIMA 111-1.28	1.28 GPF, ELONGATED BOWL, ADA HEIGHT, EVERCLEAN SURFACE, PROVIDE WITH SEAT, BASIS OF DESIGN IS AMERICAN STANDARD 5905110.	WC-2
UR-1	URINAL	WALL	-	2	1 1/2	1	AMER. STD.	6042.005	VITREOUS CHINA	SLOAN	G2 OPTIMA PLUS	0.5 GPF, TOP SPUD, EVERCLEAN SURFACE. FLUSH VALVE: SLOAN G2 OPTIMA PLUS, 0.5 GPF, EXPOSED, CHROME PLATED, BATTERY POWERED, SENSOR OPERATED, OVERRIDE BUTTON.	UR-1
LAV-1	LAVATORY	COUNTER	1 1/4	1 1/4	1 1/4	1/2	AMER. STD.	9494001	VITREOUS CHINA	SLOAN	SF-2150-4	DROP-IN SINK, ADA COMPLIANT, P-TRAP, STOPS AND SUPPLIES, SHIELDING GUARDS.  0.5 GPM AUTOMATIC FAUCET, BATTERY OPERATED, BELOW DECK THERMOSTATIC MIXING VALVE, ADJUST TO PROVIDE 105°F WATER TO FAUCET.	LAV-1
DF-1	DRINKING FOUNTAIN	WALL	1 1/4	1 1/4	1 1/4	3/8	ELKAY	LZWS-EDFPBM114K	STAINLESS STEEL		-	FULLY ASSEMBLED ONE-LEVEL DRINKING FOUNTAIN, INSTALL AT ADA HEIGHT, FLEXI-GUARD SAFETY BUBBLER, FRONT PUSH BUTTON, STAINLESS STEEL BACK PANEL, SURFACE MOUNTING PLATE, PROVIDE ACCESS PANEL FOR ACCESS TO TRAPS AND WATER SUPPLY SHUT-OFF.	DF-1
GENERAL N	ENERAL NOTE: ALL PLUMBING FIXTURES USED TO CONVEY POTABLE WATER THAT COULD BE USED FOR HUMAN CONSUMPTION SHALL BE LEAD-FREE IN ACCORCANCE WITH THE FEDERAL REDUCTION OF LEAD IN DRINKING WATER ACT.												







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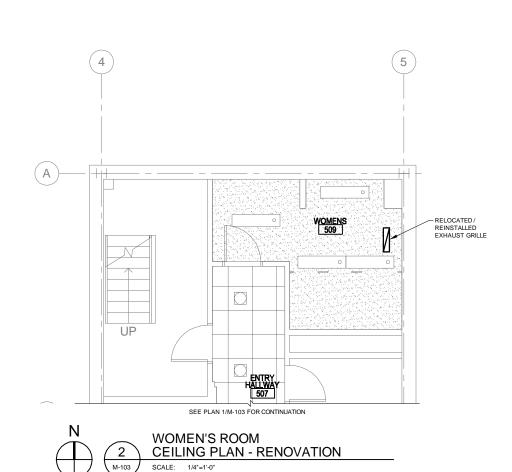
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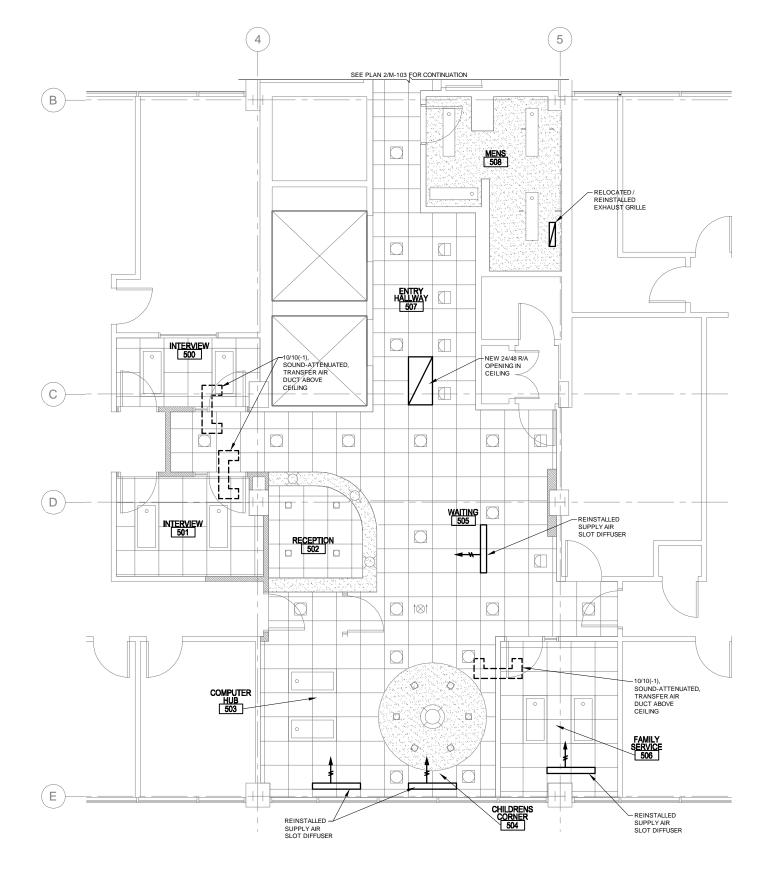
**5TH FLOOR LOBBY** RENOVATION

Project No. 01124 08278 00258 TANANA CHIEFS CONFERENCE 122 1ST AVENUE FAIRBANKS, AK 99701


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**RENOVATION -**FLOOR PLAN










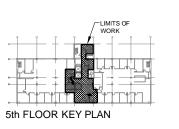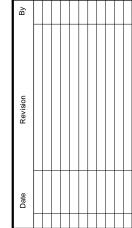





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**RENOVATION -CEILING PLAN** PLAN

Sheet No.:

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STANTEC W.O. 2046049200 I

#### **ELECTRICAL ABBREVIATIONS**

ADDITIVE ABOVE FINISHED FLOOR AFG ABOVE FINAL GRADE ABANDON IN PLACE ALTERNATE APPROX APPROXIMATE BLDG CLG CEILING CONDUIT CONDUIT ONLY CIRCUIT BREAKER CURRENT TRANSFORMER COPPER DIRECT BURY DISC DISCONNECT EXISTING EGC EQUIPMENT GROUND CONDUCTOR EMERGENCY FMT ELECTRICAL METALLIC TUBING ETR EXISTING TO REMAIN GROUNDING ELECTRODE CONDUCTOR GEC GFCI GROUND FAULT CIRCUIT INTERRUPTOR GRND GROUND HOT OR HEIGHT INTERMEDIATE METAL CONDUIT LIGHTING CONTROLS CONTACTOR LFMC LIQUID-TITE FLEX METAL CONDUIT MAIN BONDING JUMPER MCB MAIN CIRCUIT BREAKER MDP MAIN DISTRIBUTION PANEL MOUNTING HEIGHT MLO MAIN LUG ONLY MOMENTARY MTS MANUAL TRANSFER SWITCH NEUTRAL NOT APPLICABLE NORMALLY CLOSED NORMALLY OPEN NFS NON-FROST SUSCEPTIBLE NOT IN CONTRACT NIGHT LIGHT NL NTS NOT TO SCALE ON CENTER PUBLIC ADDRESS RIGID METAL CONDUIT SWITCH TAMPER RESISTANT UNLESS OTHERWISE NOTED

WIRE GUARD WEATHER-PROOF

#### **ELECTRICAL LEGEND**

#### POWER / CONTROL LIGHTING COMMUNICATIONS LETTER(S) INDICATE LIGHT FIXTURE TYPE DUPLEX RECEPTACLE, GFCI TYPE $\nabla X \quad \nabla X$ WALL/FLOOR MOUNTED DATA OUTLET, SUBSCRIPT DENOTES NUMBER OF OUTLETS PER JUNCTION BOX (DEFAULT, ONE) LIGHT FIXTURE, SURFACE MOUNT do oo DUPLEX RECEPTACLE, WALL/FLOOR MOUNTED WALL/FLOOR MOUNTED TELEPHONE OUTLET, SUBSCRIPT DENOTES NUMBER OF ± dea LIGHT FIXTURE, RECESS MOUNT DOUBLE DUPLEX RECEPTACLE, WALL/FLOOR MOUNTED WALL/FLOOR MOUNTED COMBINATION DATA AND TELEPHONE OUTLET, SUBSCRIPT EMERGENCY LIGHT FIXTURE, SURFACE MOUNT MULTI-OUTLET SURFACE RACEWAY ASSEMBLY $\mathbf{Y}$ DENOTES NUMBER OF DATA OUTLETS PER JUNCTION BOX (DEFAULT, ONE) **\_** • EMERGENCY LIGHT FIXTURE, RECESS MOUNT CONTROL OR TERMINAL CABINET, TYPE AS NOTED XXX TV TELEVISION OUTLET . NIGHT LIGHT FIXTURE, SURFACE MOUNT PANELBOARD, SURFACE/FLUSH MOUNTED SPEAKER, WALL/CEILING MOUNTED HS S **(J)** NIGHT LIGHT FIXTURE, RECESS MOUNT JUNCTION BOX TIME CLOCK TC ( */*° NIGHT/EMERGENCY LIGHT FIXTURE, SURFACE MOUNT EQUIPMENT CONNECTION TS EMPLOYEE TIME CLOCK 0 NIGHT/EMERGENCY LIGHT FIXTURE, RECESS MOUNT $\bigcirc$ THERMOSTAT FIRE ALARM LIGHT FIXTURE, WALL MOUNT CONDUIT STUBBED & CAPPED OR BUSHED AS NOTED PΧ $\bigcirc$ SURFACE CEILING MOUNTED LIGHT FIXTURE RACEWAY UP FIRE ALARM PULL STATION ЮΨ **(S)** X WALL MOUNTED LIGHT FIXTURE PHOTOELECTRIC SMOKE DETECTOR, "I" DENOTES IONIZATION RACEWAY DOWN RECESSED CEILING WALL-WASH FIXTURE UNDERGROUND OR UNDER FLOOR CIRCUIT FIRE ALARM HORN/STROBE RECESSED CEILING MOUNTED LIGHT FIXTURE CIRCUIT CONCEALED / ABOVE CEILING FIRE ALARM HORN/STROBE, CEILING MOUNTED Ø Ø PENDANT LIGHT FIXTURE BRANCH CIRCUIT HOMERUN WITH GROUND, NEUTRAL AND FIRE ALARM STROBE 1111 ፟ EXIT SIGN, CEILING MOUNT, ARROW INDICATES DIRECTION ••• DOOR HOLD B-2 INDICATES PANEL AND CIRCUIT NUMBER ՛፟⊗ EXIT SIGN, WALL MOUNT, ARROW INDICATES DIRECTION **NOTATION** ♦ OCCUPANCY SENSOR, LETTER DENOTES TYPE A = INFRARED WALL-SWITCH MOUNT G = ULTRASONIC, CEILING MOUNT G = INFRARED, WALL AND CEILING MOUNT, FOR AIR HANDLER UNIT (#) REFERENCE TO SHEET NOTE **#** REFERENCE TO REVISION CONTROL IN CONJUNCTION WITH HAZARDOUS GAS DETECTION SYSTEM LIGHT SWITCH NO LETTER = SINGLE-POLE SWITCH 2 = 2-WAY SWITCH 3 = 3-WAY SWITCH DRAWING CONVENTION 4 = 4-WAY SWITCH K = KEY OPERATED SWITCH NEW OR DEMOLITION ELECTRICAL ITEMS ARE TYPICALLY INDICATED BY ELECTRICAL ITEMS ARE TYPICALLY INDICATED BY DASHED & LIGHTWEIGHT LINES. UNLESS OTHERWISE NOTED.

#### ELECTRICAL SERVICE LOAD:

NET CHANGE TO LOAD ON BUILDING SERVICE IS A
 DECREASE OF 375 WATTS, 0,45A AT 480V.

EXISTING LIGHTIN	IG REMOVED:	2585 W
(2068 x 125% CO	NTINUOUS)	
NEW LIGHTING AD	DDED:	1760 W
(1408 x 125% CO	NTINUOUS)	
EXISTING RECEPT	FACLES REMOVED:	1710 W
(3420 x 50% PER	NEC 220.44)	
NEW RECEPTACL	ES ADDED:	2160 W
(4320 x 50% PER	NEC 220.44)	

				LIG	HT FI	XTURE SC	HEDULE				
ID DESCRIPTION FIXTURE COLOR CONTROL MOUNTING MTG CLG MANUFACTURERS						NOTES					
		VOLTAGE	WATTS	LUMENS	TEMP			HEIGHT	TYPE	CATALOG NO.	
Α	6" LED DOWNLIGHT	120	30	2500	3500K	-	RECESSED	-	GRID	GOTHAM	1
										EVO-6AR-DLR-LSS	
В	LOW-VOLTAGE PENDANT	120	8	500	3500K	-	PENDANT	SEE	GWB	TECH LIGHTING	2,3,5
								NOTE		700-FIRF-MP-X-S-LED830	
С	NOT USED										
D	2" LED DOWNLIGHT	120	7	500	3500K	-	RECESSED	-	GWB	GOTHAM	
										ICO-2AR-LSS-45D	
D2	2" LED DOWNLIGHT	120	10	750	3500K	-	RECESSED	-	GWB	GOTHAM	
										ICO-2AR-LSS-45D	
DS	2" LED DOWNLIGHT	120	14	1000	3500K		SURFACE	-	GWB/	GOTHAM	4
									WOOD	ICO CYL-2AR-LSS-45D-FCMS	
Е	EXIT SIGN WITH	120	-	-	-	-	VARIES	7'-0"	VARIES	EVENLITE	
	BATTERYLESS EMERGENCY							(WALL)		SENTRY HYBRID-WHITE	
F	2x4 VOLUMETRIC LED	120	47	4800	3500K	BI-LEVEL	RECESSED	-	GRID	LITHONIA	1
										2VTL4-ADP	
G	LED SURFACE WRAP	120	32	3200	3500K	-	SURFACE	-	GWB	AXIS	1
										PWSLED-B3-MF-S4-W	
Н	4" LED WALL WASH	120	24	750	3500K	-	RECESSED	-	GRID	GOTHAM	
										EVO-WW-4AR-LSS	
BBRE	VIATIONS:			1		1		GENERAL	NOTES:		-
GWB	= GYPSUM WALL BOARD	CWA =	CONSTANT	WATTAGE		SFP = SEE FLOC	R PL AN	1. MOUNT	NG HEIGHTS	S SHOWN ARE TYPICAL FOR FIXTURE	TYPE
GRID	SRID = LAY-IN GRID AUTOTRANSFORMER SMHS = SEE MOUNTING UNLESS OTHERWISE INDICATED ON THE PLANS.										

HEIGHT SCHEDULE

2. FIXTURE TYPES INDICATED IN EACH ROOM ON THE PLANS ARE

ROOM UNLESS OTHERWISE INDICATED.

TYPICAL FOR ALL FIXTURES USING THE SAME SYMBOL IN THAT

## HPF = HIGH POWER FACTOR LIGHT FIXTURE SCHEDULE NOTES:

STR = EXPOSED STRUCTURE

ELEC = ELECTRONIC

PROVIDE EMERGENCY FIXTURES (AS INDICATED ON PLAN) WITH INTEGRAL BATTERY BACKUP.

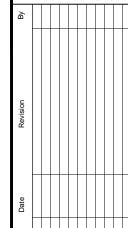
MH = METAL HALIDE

QTZ = QUARTZ

HPS = HIGH PRESSURE SODIUM

- 2. PROVIDE WITH 4" CANOPY WITH INTERGRAL RECESSED TRANSFORMER.
- 3. FIELD COORDINATE FINAL MOUNTING HEIGHT.
- 4. MOUNT FIXTURE TO GWB CEILING ABOVE WOOD SLAT CEILING. COORDINATE OPENINGS IN WOODS SLATS WITH FIXTURE LOCATIONS.
- 5. SHADE COLOR AS SELECTED BY ARCHITECT FROM STANDARD COLOR OPTIONS.

OF AL SO 49 TH LUCAS SCHNELLER E-11399 PROFESSIONAL





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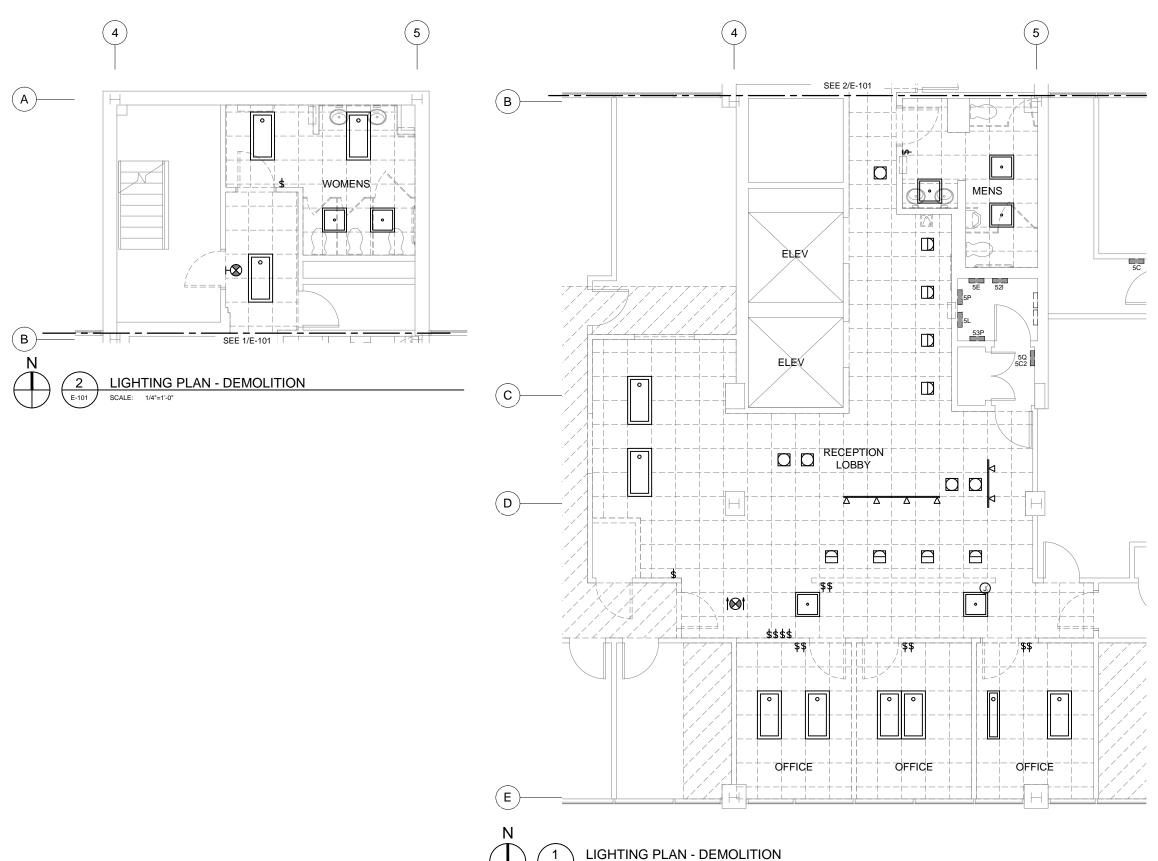
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Drawn DGB
Checked LPS
Date 10/15/2015
Sheet Contents:

ELECTRICAL LEGEND, ABREVIATIONS & SCHEDULES

Sheet No.:

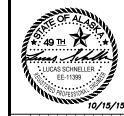
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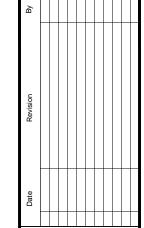


SCALE: 1/4"=1'-0"

#### GENERAL NOTES:

- REMOVE DEVICES INDICATED, INCLUDING ALL ASSOCIATED ACCESIBLE CONDUIT AND CONDUCTORS BACK TO PANEL OR PREVIOUS DEVICE TO REMAIN ON CIRCUIT, UNLESS OTHERWISE INDICATED.
- EXISTING CONDUIT ABOVE CEILING MAY BE
  REUSED WHERE APPROPRIATE FOR NEW FIXTURE
  LAYOUT. ALL UNUSED CONDUITS SHALL BE







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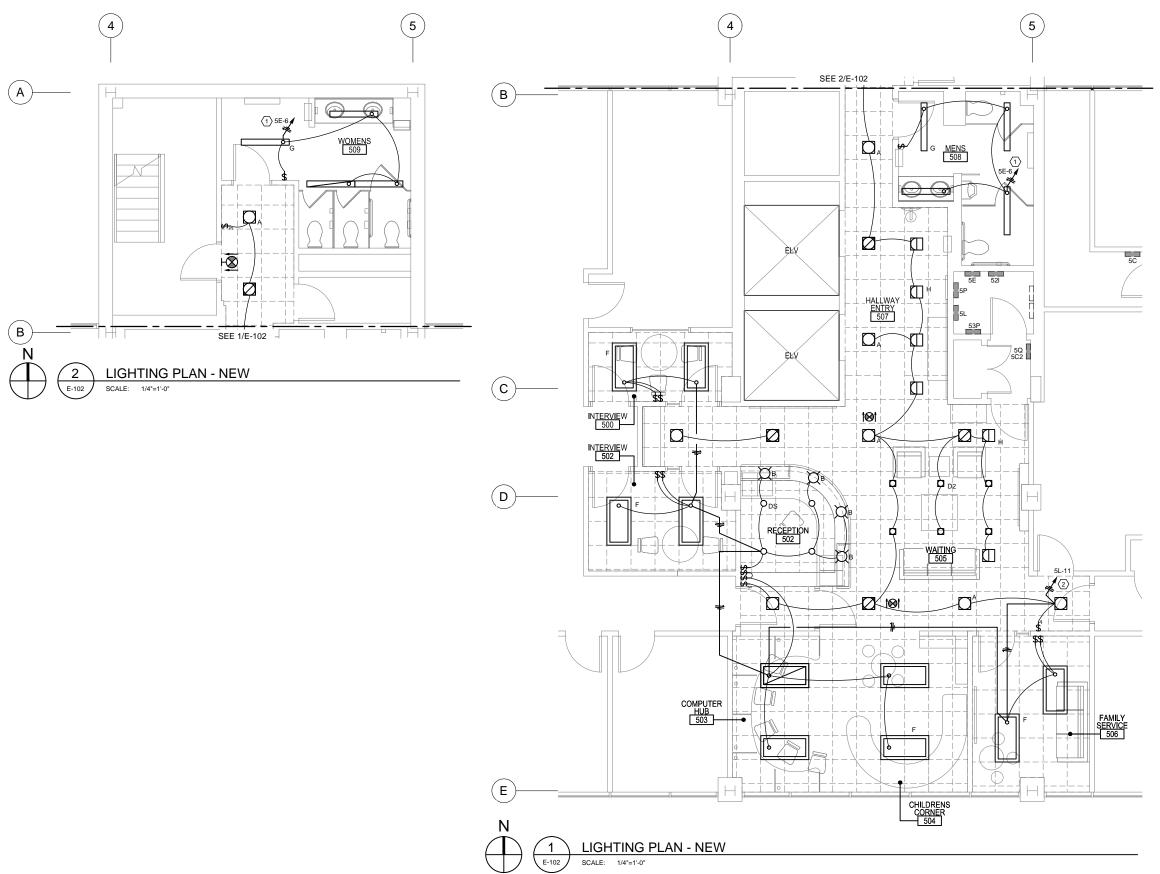
Sheet Contents: LIGHTING PLAN -DEMOLITION

Sheet No.:

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STANTEC W.O. 2046049200

/-LIMITS OF WORK 5th FLOOR KEY PLAN




- ALL EXIT SIGNS ARE TYPE E. SERVE EXIT SIGNS FROM UNSWITCHED LIGHTING CIRCUIT SERVING THE AREA CONTAINING THE EXIT SIGN.
- EXISTING CIRCUIT NUMBERS INDICATED ARE DERIVED FROM LIMITED SITE INVESTIGATION. FIELD VERIFY EXISTING CIRCUITS PRIOR TO STARTING WORK.

#### SHEEET NOTES:

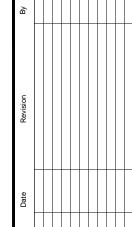- RECONNECT TO EXISTING CIRCUIT. NET CHANGE IN LOAD IS A REDUCTION OF 171 WATTS, 0.62A AT 277V.
- RECONNECT TO EXISTING CIRCUIT. NET CHANGE IN LOAD IS AN INCREASE OF 271 WATTS, 0.98A AT 277V. VERIFY CIRCUIT LOAD/CAPACITY AND NOTIFY ENGINEER IF NEW CIRCUIT LOAD WILL EXCEED 12A ON EXISTING 20A BREAKER.







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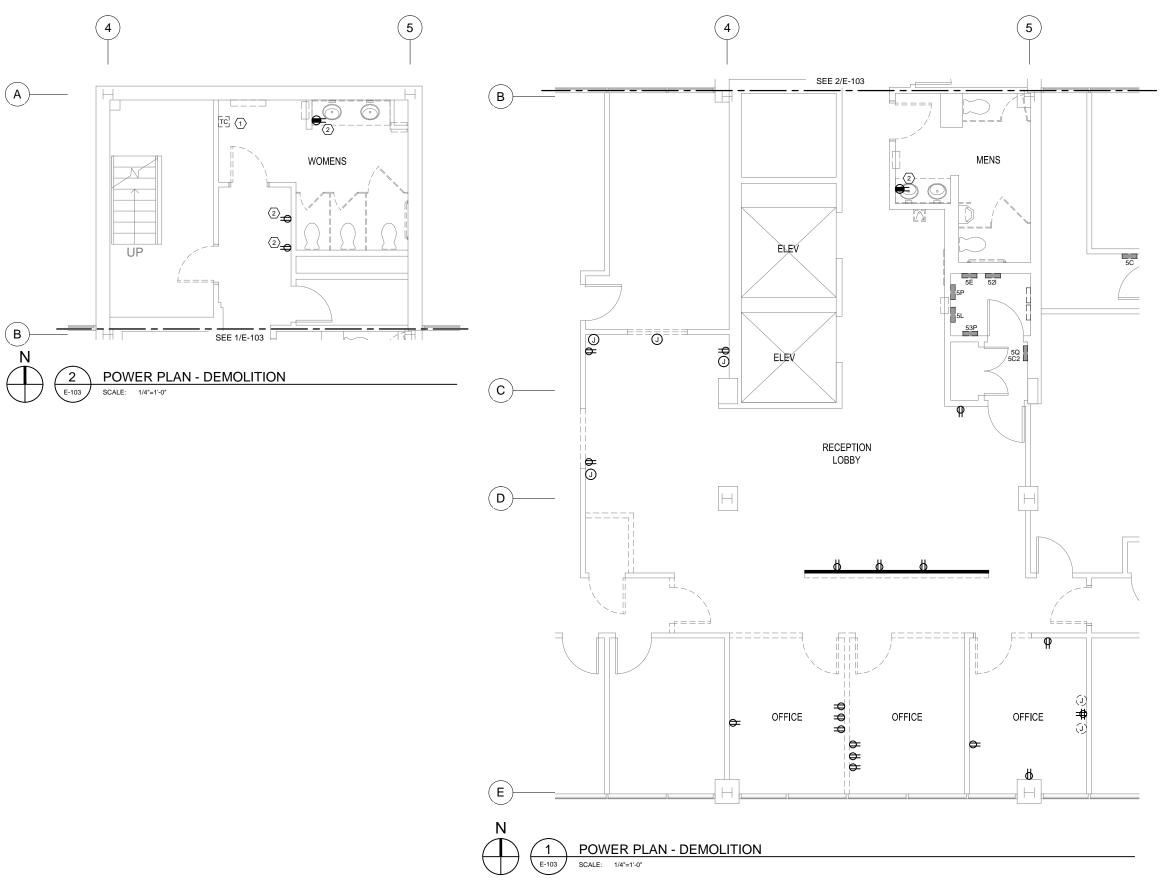
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Sheet Contents:
LIGHTING PLAN NEW

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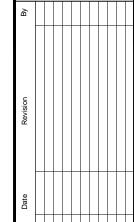


REMOVE DEVICES INDICATED, INCLUDING ALL
ASSOCIATED ACCESIBLE CONDUIT AND
CONDUCTORS BACK TO PANEL OR PREVIOUS
DEVICE TO REMAIN ON CIRCUIT, UNLESS
OTHERWISE INDICATED.

#### SHEEET NOTES: $\langle X \rangle$

- VERIFY EQUIPMENT SERVED BY TIME CLOCK.
   REMOVE IF NO LONGER IN USE.
- 2. REMOVE DEVICE AND WALLPLATE. EXISTING DEVICE BOX AND CONDUCTORS TO REMAIN.







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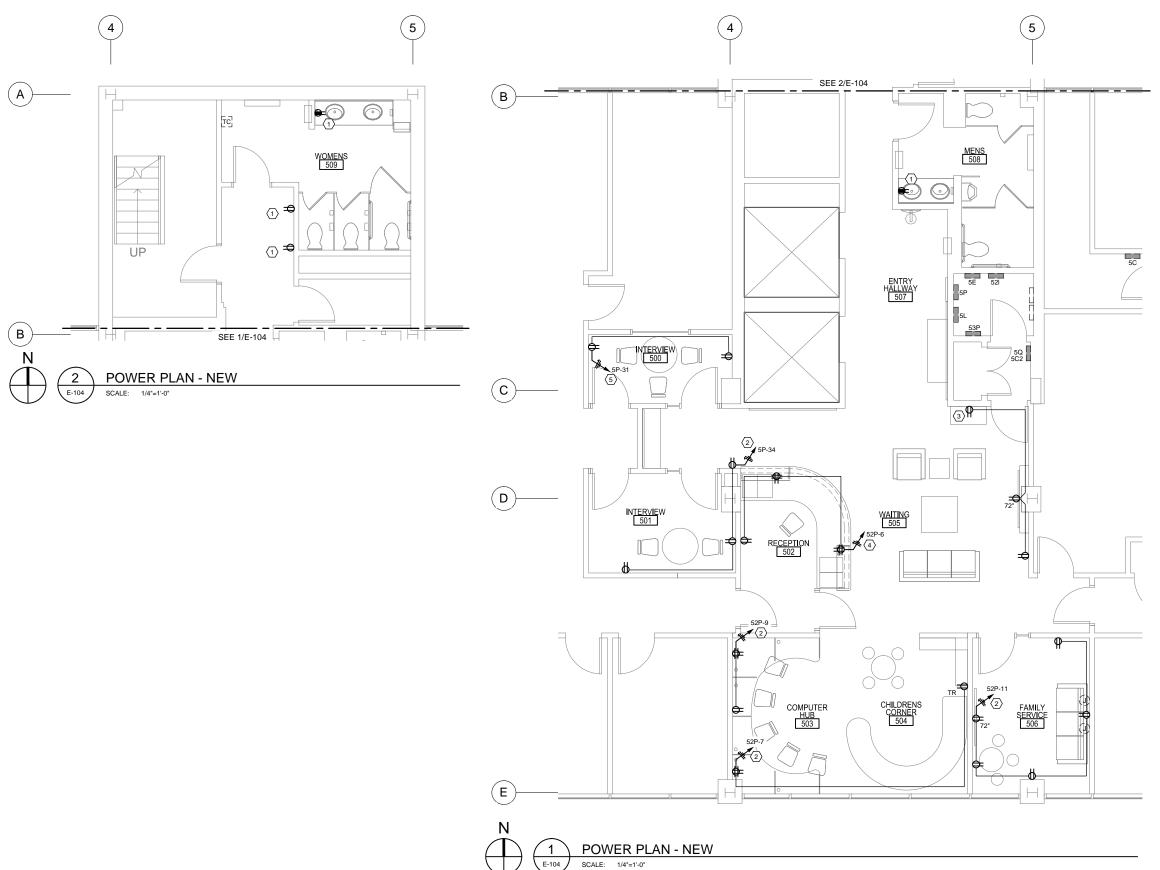
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POWER PLAN DEMOLITION

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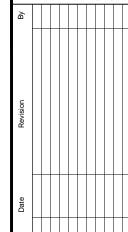


 EXISTING CIRCUIT NUMBERS INDICATED ARE DERIVED FROM LIMITED SITE INVESTIGATION. FIELD VERIFY EXISTING CIRCUITS PRIOR TO STARTING WORK.

#### SHEEET NOTES: X

- INSTALL NEW DEVICE AND WALLPLATE IN EXISTING DEVICE BOX. RECONNECT TO EXISTING CONDUCTORS.
- SERVE RECEPTACLES FROM EXISTING RECEPTACLE CIRCUIT IN THIS AREA. NO NET CHANGE IN LOAD.
- 3. EXTEND EXISTING RECEPTACLE CIRCUIT FROM THIS LOCATION. NET CHANGE IN LOAD IS AN INCREASE OF 360 WATTS, 3A AT 120V. VERIFY TOTAL NUMBER OF RECEPTACLES ON CIRCUIT AND NOTIFY ENGINEER IF MORE THAN EIGHT.
- SERVE RECEPTACLES FROM EXISTING RECEPTACLE CIRCUIT IN THIS AREA. NET CHANGE IN LOAD IS AN INCREASE OF 360 WATTS, 3A AT 120V. VERIFY NO OTHER RECEPTACLES ARE SERVED BY THIS CIRCUIT.
- 5. SERVE RECEPTACLES FROM EXISTING RECEPTACLE CIRCUIT IN THIS AREA. NET CHANGE IN LOAD IS AN INCREASE OF 360 WATTS, 3A AT 120V. VERIFY TOTAL NUMBER OF RECEPTACLES ON CIRCUIT AND NOTIFY ENGINEER IF MORE THAN EIGHT.







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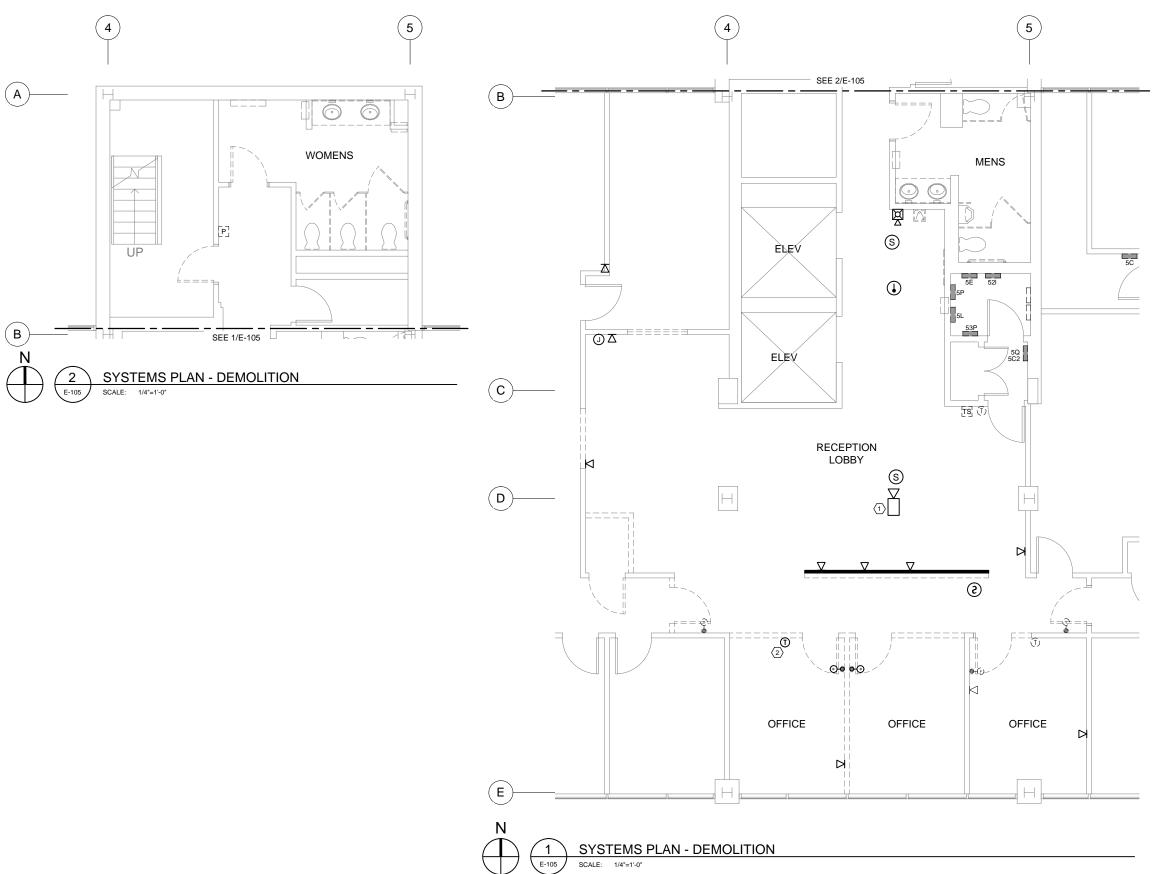
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POWER PLAN NEW

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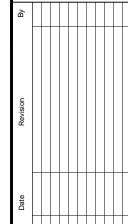


- REMOVE DEVICES INDICATED, INCLUDING ALL ASSOCIATED ACCESSIBLE CONDUIT AND CONDUCTORS BACK TO SOURCE OR PREVIOUS DEVICE TO REMAIN ON CIRCUIT, UNLESS OTHERWISE INDICATED.
- 2. EXISTING FIRE ALARM SYSTEM IS A SIMPLEX 4100U.

#### SHEEET NOTES: X

- REMOVE EXISTING CAMERA AND STORE FOR REINSTALLATION. EXISTING WIRING TO REMAIN.
- REMOVE EXISTING THERMOSTAT AND STORE FOR REINSTALLATION. EXISTING WIRING TO REMAIN.







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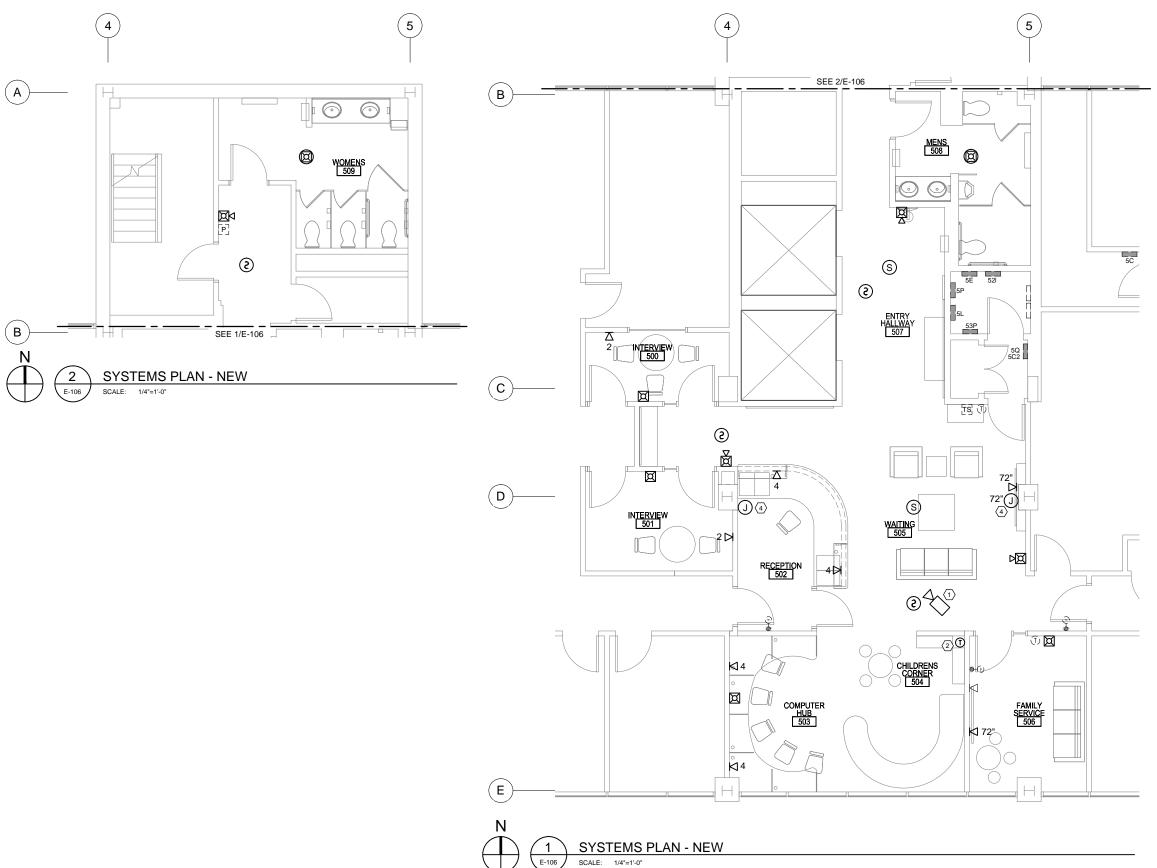
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SYSTEMS PLAN DEMOLITION

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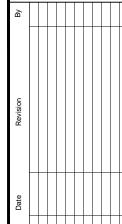


- CONNECT NEW FIRE ALARM DEVICES TO EXISTING SIGNAL LINE AND NOTIFICATION CIRCUITS. VERIFY CAPACITY OF NOTIFICATION CIRCUITS RECEIVING ADDITIONAL DEVICES.
- CONNECT NEW SPEAKERS TO EXISTING SPEAKER CIRCUIT.

#### SHEEET NOTES: X

- REINSTALL EXISTING CAMERA.
   REROUTE/EXTEND EXISTING WIRING AS REQUIRED.
- REINSTALL EXISTING THERMOSTAT.
   REROUTE/EXTEND EXISTING WIRING AS REQUIRED.
- 3. EXTEND CAT-6 HOMERUN CABLE FROM EACH DATA JACK TO NEW 48-PORT CAT-6 PATCH PANEL IN TELECOM ROOM. FIELD VERIFY LOCATION.
- INSTALL 4" SQUARE BOX WITH 2-GANG MUD RING, BLANK WALL-PLATE, AND 1" CONDUIT STUBBED TO ABOVE ACCESSIBLE GRID CEILING.







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SYSTEMS PLAN NEW

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#### **SPECIFICATIONS**

#### GENERAL

- ALL WORK SHALL CONFORM TO THE LATEST EDITION OF THE NATIONAL ELECTRICAL CODE (NEC) AND ALL STATE AND LOCAL CODES AND CODE AMENDMENTS.
- OBTAIN ALL PERMITS AND PAY ALL FEES REQUIRED BY THIS
- MAINTAIN RESPONSIBILITY FOR THE CONDITION OF ALL MATERIALS USED. IF LOST, STOLEN, OR DAMAGED, MATERIALS SHALL BE REPLACED AT NO EXTRA COST TO THE OWNER.
- ALL WORK SHALL BE PERFORMED BY WORKMEN SKILLED IN AND REGULARLY EMPLOYED IN THE TRADE. INSTALL ALL PRODUCTS IN A NEAT AND WORKMANLIKE MANNER, PER MANUFACTURER'S INSTRUCTIONS AND IN COMPLIANCE WITH NECA 1 "STANDARD PRACTICE FOR GOOD WORKMANSHIP IN ELECTRICAL
  CONTRACTING" AS A MINIMUM. COMPLY WITH NFPA 70E SAFETY RULES AS A MINIMUM.
- PERFORM ALL CUTTING DRILLING AND PATCHING OF WALLS AND FLOORS NECESSARY FOR A COMPLETE INSTALLATION IN COORDINATION WITH OTHER TRADES.
- COORDINATION INSTALLATION AND ARRANGEMENT OF COMPONENTS AND EQUIPMENT WITH OTHER TRADES AND INSTALL TO FACILITATE ACCESS FOR FUTURE MAINTENANCE, REPAIR, AND REPLACEMENT WITHOUT INTERFERENCE TO ADJACENT WORK
- REMOVE ALL DEBRIS AND SURPLUS MATERIAL FOR THE PREMISES AS PROGRESS OF THE WORK DICTATES.
- ALL ELECTRICAL EQUIPMENT SHALL BE LISTED BY A NATIONALLY 1.8. RECOGNIZED TESTING LABORATORY (NRTL).

#### 2. PRODUCTS AND SUBMITTALS

- SUBMIT PRODUCT DATA, CERTIFICATES, AND SHOP DRAWINGS TO THE ENGINEER. PROVIDE SUBMITTALS FOR PANELBOARDS, WIRING DEVICES, LIGHT FIXTURES, CONDUCTORS, EQUIPMENT MOTOR STARTERS, ALARM PANELS AND DEVICES, AND TELECOMMUNICATIONS FOLIPMENT
- ALL PRODUCTS SHALL BE NEW AND LISTED OR LABELED BY A NATIONALLY RECOGNIZED TESTING LABORATORY (NRTL) FOR THE INTENDED USE, UNLESS OTHERWISE INDICATED.
- 23 MATCH EXISTING WHERE A LINIFORM INSTALL ATION EXISTS. UNLESS OTHERWISE INDICATED OR APPROVED.
  PROVIDE SIMILAR ITEMS FROM THE SAME MANUFACTURER
- 2.4. THROUGHOUT THE PROJECT.

- REMOVE ALL EXPOSED ELECTRICAL WORK IN DEMOLITION AREAS, ACCESSIBLE CIRCUITS AND RACEWAYS SHALL BE REMOVED BACK TO THE SOURCE OR TERMINAL EQUIPMENT UNLESS OTHERWISE INDICATED OR WHERE CIRCUITS SERVE AREAS TO REMAIN.
- REMOVE CONDUCTORS FROM INACCESSIBLE CONDUITS INACCESSIBLE CONDUITS MAY BE ABANDONED IN PLACE.
  TERMINATE CONDUITS 2 INCHES BELOW GRADE OR SURFACE OF ADJACENT CONSTRUCTION.
- REMOVE, STORE, CLEAN, REINSTALL, RECONNECT, AND MAKE OPERATIONAL COMPONENTS INDICATED FOR RELOCATION.

#### 4 FLECTRICAL DISTRIBUTION

- OVERCURRENT PROTECTIVE DEVICES SHALL BE CIRCUIT
  BREAKER TYPE, BOLT-IN DESIGN. CIRCUIT BREAKERS SHALL BE
  MOLDED CASE, THERMAL-MAGNETIC DESIGN. INSTALL GROUND-FAULT CIRCUIT INTERRUPTER (GECI) CIRCUIT BREAKERS WHERE INDICATED ON THE DRAWINGS AND REQUIRED BY CODE.
- DISCONNECT SWITCHES SHALL BE HEAVY-DUTY TYPE, FUSED
- OR NON-FUSED AS INDICATED ON THE DRAWINGS.
  MAGNETIC-TYPE MOTOR STARTERS SHALL BE COMBINATION UNITS INCORPORATING A NON-FUSED DISCONNECT
- 44 PROVIDE MOTOR STARTERS WITH THERMAL OR ELECTRONIC OVERLOAD ELEMENTS SIZED BASED ON THE FULL LOAD

#### 5 RACEWAYS AND BOXES

- CONDUIT TYPES SHALL BE:
  . INTERIOR EXPOSED BELOW 4'AFF: RMC OR IMC. INTERIOR EXPOSED ABOVE 4'AFF: RMC, IMC, OR EMT
- INTERIOR CONCEALED: RMC, IMC, OR EMT
- SUBJECT TO VIBRATION SHALL BE:
- INTERIOR DRY LOCATIONS: FMC OR LEMC INTERIOR, DAMP OR WET LOCATIONS: LFMC
  MINIMUM CONDUIT SIZE SHALL BE 1/2".
- CONDUIT FITTINGS SHALL BE GALVANIZED STEEL AND HAVE 5.4.
- NYLON INSULATED THROATS 5.5. CONDUIT FITTINGS FOR RMC AND IMC SHALL BE THREADED
- CONDUIT FITTINGS FOR EMT SHALL BE STEEL COMPRESSION 5.6.
- PENETRATIONS THROUGH FIRE-RATED ASSEMBLIES SHALL BE
- SEALED TO MAINTAIN THE FIRE RATING. CONDUITS PASSING FROM HEATED TO COLD SPACES SHALL BE THERMALLY SEALED TO PREVENT AIR AND MOISTURE TRANSFER. CONDUIT SHALL BE SEALED WITH REMOVABLE
- DUCT SEALANT AT AN ACCESSIBLE LOCATION. CONDUITS SHALL BE CUT SQUARE AND ENDS REAMED TO
- MAXIMUM CONDUIT BEND SHALL BE 90 DEGREES, WITH NOT 5.10. MORE THAN THREE 90 DEGREE BENDS OR EQUIVALENT BETWEEN PULL POINTS.
- JUNCTION AND DEVICE BOXES SHALL BE SUITABLE FOR USE AT THE INSTALLED LOCATION AND ARRANGED TO ACCEPT THE INTENDED DEVICE OR EQUIPMENT. JUNCTION AND DEVICE BOXES SHALL BE:
  . INTERIOR EXPOSED BELOW 5'AFF: GALVANIZED CAST IRON
- OR CAST ALUMINUM WITH THREADED CONDUIT HUBS. INTERIOR EXPOSED ABOVE 5'AFE: GALVANIZED SHEET
- STEEL.
  INTERIOR CONCEALED: GALVANIZED SHEET STEEL. THE ENTIRE CONDUIT SYSTEM SHALL BE MECHANICALLY AND
- ELECTRICALLY CONTINUOUS FROM THE SOURCE TO ALL DEVICES AND GROUNDED IN ACCORDANCE WITH THE NEC. 5.13. INSTALL CONDUIT AND DEVICES CONCEALED AND FLUSH IN FINISHED AREAS, CONDUIT AND DEVICES MAY BE INSTALLED EXPOSED IN UNFINISHED AREAS AND MECHANICAL ROOMS, AND AS INDICATED ON THE DRAWINGS.

#### 6. CONDUCTORS AND CABLES

- CONDUCTORS SHALL BE COPPER SOLID FOR 12AWG AND SMALLER, STRANDED FOR 10AWG AND LARGER. INSULATION
- INTERIOR, HEATED: THHN-THWN OR XHHW. INTERIOR LINHEATED: XHHW
- MINIMUM CONDUCTOR SIZES SHALL BE 12AWG FOR POWER AND 18AWG FOR LOW-VOLTAGE AND CONTROLS. CIRCUIT CONDUCTORS SHALL BE INCREASED IN SIZE FOR VOLTAGE DROP BASED ON THE CIRCUIT LENGTH, 12AWG UP TO 100', 10AWG UP TO 200', 8AWG OVER 200'. INCREASE SIZE OF CONDUIT AS REQUIRED FOR LARGER CONDUCTOR SIZES. TYPE MC CABLE MAY BE USED FOR BRANCH CIRCUIT WIRING
- BETWEEN DEVICES. HOMERUNS SHALL BE INDIVIDUAL CONDUCTORS IN CONDUIT. MC CABLE SHALL HAVE A GALVANIZED STEEL SHEATH AND INCLUDE AN EQUIPMENT GROUNDING CONDUCTOR
- CONNECTORS AND SPLICES SHALL BE FACTORY-FABRICATED TWIST-ON, COMPRESSION, OR BOLTED, WITH THE AMPACITY, RATING, TYPE, AND MATERIAL APPROPRIATE FOR THE APPLICATION. PUSH-IN SPRING-TYPE CONNECTORS ARE NOT
- PROVIDE A SEPARATE GREEN INSULATED EQUIPMENT GROUNDING CONDUCTOR IN ALL POWER AND CONTROL CIRCUITS. INCREASE SIZE OF GROUNDING CONDUCTOR
  PROPORTIONALLY AS REQUIRED WHERE POWER CONDUCTORS ARE OVERSIZED FOR VOLTAGE DROP.

#### WIRING DEVICES

- 7.1. RECEPTACLES SHALL BE HEAVY-DUTY GRADE, 20AMP, DUPLEX GROUNDING TYPE RECEPTACLES. RECEPTACLES SHALL BE TAMPER RESISTANT WHERE REQUIRED BY CODE OR SPECIFIED
- SWITCHES SHALL BE HEAVY-DUTY GRADE, 20AMP, SINGLE POLE, THREE-WAY, FOUR-WAY, KEY-OPERATED, AND PILOT-LIGHT AS INDICATED ON THE DRAWINGS.
  GROUND-FAULT CIRCUIT INTERRUPTER (GFCI) RECEPTACLES
- SHALL BE HEAVY-DUTY GRADE, 20AMP, NON-FEED-THROUGH DUPLEX RECEPTACLES WITH CLASS A TRIP, TEST AND RESET BUTTONS, AND A PROTECTION INDICATOR LIGHT.
  OCCUPANCY SENSORS SHALL HAVE ADJUSTABLE SENSITIVITY
- AND TIME DELAYS AND SHALL BE SELECTED TO PROVIDE SENSOR COVERAGE OF THE ENTIRE ROOM.
- WALL-SWITCH MOUNTED, PASSIVE INFRARED TYPE, 180-DEG FIELD OF VIEW, WITH INTEGRAL RELAY.
- WALL-SWITCH MOUNTED, ULTRASONIC TYPE, WITH 742 INTEGRAL RELAY
- WALL-SWITCH MOUNTED, DUAL-TECHNOLOGY TYPE, WITH INTEGRAL RELAY.
- CEILING MOUNTED, PASSIVE INFRARED TYPE, WITH
- SEPARATE RELAY/POWER SUPPLY.
  CEILING MOUNTED, ULTRASONIC TYPE, WITH SEPARATE RELAY/POWER SUPPLY.
- CEILING MOUNTED, DUAL-TECHNOLOGY TYPE, WITH
- WIRING DEVICES SHALL BE IVORY. WALL PLATES SHALL BE-
- FINISHED AREAS: SATIN-FINISH STAINLESS STEEL. UNFINISHED AREAS: GALVANZIED STEEL.
- LIGHTING CONTACTORS SHALL HAVE ELECTRICALLY-HELD COILS INDICATOR LIGHTS CONTROL SWITCHES AND PILOT RELAYS AS REQUIRED, AND ENCLOSURES RATED FOR THE INSTALLED ENVIRONMENT.

- LIGHT FIXTURES SHALL BE AS SHOWN AND SCHEDULED ON THE DRAWINGS OR AN APPROVED EQUAL.
- LIGHT FIXTURES SHALL BE PROVIDED AND INSTALLED COMPLETE WITH LAMPS OR LEDS, BALLASTS OR DRIVERS, AND
- EMERGENCY BATTERY UNITS SHALL OPERATE LIGHT FIXTURE CONTINUOUSLY AT FULL OR REDUCED OUTPUT. THE UNIT SHALL INCLUDE INTEGRAL NICKEL-CADMIUM BATTERIES, CHARGING AND TRANSFER ELECTRONICS, TEST PUSHBUTTON, AND CHARGE INDICATOR LIGHT.
- EXIT SIGNS SHALL BE LED TYPE, WITH INTEGRAL NICKEL-CADMIUM BATTERIES, CHARGING AND TRANSFER ELECTRONICS, TEST PUSHBUTTON, AND CHARGE INDICATOR
- LED DRIVERS SHALL BE ELECTRONIC RATED FOR THE LEDS INSTALLED IN THE FIXTURE, HAVE A MINIMUM POWER FACTOR
  OF 0.9 AND A MAXIMUM TOTAL HARMONIC DISTORTION (THD) OR 20% DRIVERS SHALL CARRY A 5 YEAR WARRANTY
- LEDS SHALL HAVE A MINIMUM RATED LIFE TO L70 OR 50,000
- INTERIOR: 3000K OR 3500K AS SCHEDULED, 80 CRI MINIMUM. LIGHT FIXTURES INSTALLED IN SUSPENDED CEILINGS SHALL BE SUPPORTED FROM THE CEILING GRID. FIXTURES SHALL BE SECURED TO THE GRID WITH CLIPS LISTED FOR THE PURPOSE INSTALL AT LEAST 1 INDEPENDENT SUPPORT WIRE FROM THE FIXTURE TO THE STRUCTURE. INSTALL AT LEAST 2
  INDEPENDENT SUPPORT WIRES LOCATED AT OPPO CORNERS OF THE FIXTURE FOR FIXTURES 4 FEET LONG OR

#### 9. TELECOMMUNICATIONS

- TELECOMMUNICATIONS HORIZONTAL CABLING SHALL BE FOUR-PAIR UTP, RATED CATEGORY 6. CABLE SHALL BE PLENUM RATED WHERE INSTALLED IN AIR-HANDLING PLENUMS. TELECOMMUNICATIONS OUTLETS SHALL CONSIST OF MODULAR
- JACKS IN TWO OR FOUR-PORT FACEPLATES. JACKS SHALL BE FOUR-PAIR, EIGHT-POSITION, RATED CATEGORY 6.
  FACEPLATES SHALL INCLUDE INSERTS FOR LABELS WITH CLEAR,
- SNAP-IN COVERS. EACH JACK SHALL BE LABELED WITH A LINIQUE DESIGNATION MATCHING THE DESIGNATION ON THE ASSOCIATED PATCH PANEL PORT. LABELS SHALL BE
- PATCH PANELS SHALL BE RATED CATEGORY 6. PANELS SHALL INCLUDE MULTIPLE PORTS WITH IDC-TYPE TERMINALS. EACH PORT SHALL BE LABELED WITH A UNIQUE DESIGNATION MATCHING THE DESIGNATION OF THE ASSOCIATED WALL JACK. PATCH PANELS SHALL HAVE ONE PORT FOR EACH FOUR-PAIR UTP CABLE PLUS 10% MINIMUM SPARE JACKS FOR FUTURE

- VOICE GRADE CROSS CONNECTS SHALL BE MADE USING 66-STYLE BLOCKS WITH IDC CONNECTORS. BLOCKS SHALL INCLUDE CONNECTORS FOR THE CABLES TERMINATED PLUS 10% MINIMUM SPARE FOR FUTURE EXPANSION.
- TELECOMMUNICATIONS CABLING SHALL BE INSTALLED IN CONDUIT WHERE CONCEALED PROVIDE PROTECTIVE BUSHINGS ON THE ENDS OF EACH CONDUIT. WHERE ACCESSIBLE, CABLING MAY BE INSTALLED USING J-HOOKS OR CABLETRAY. CABLE SUPPORTS SHALL BE SPACED NOT MORE THAN 36 INCHES APART AND CABLES SHALL BE SUSPENDED A MINIMUM OF 8 INCHES ABOVE THE CEILING
- INSTALL AND TEST CABLES IN ACCORDANCE WITH TIA/EIA-568-B 2 FOR CATEGORY 6 CABLES TEST CABLES FOR WIRE MAP, LENGTH, INSERTION LOSS, NEAR-END CROSS TALK (NEXT) LOSS, POWER SUM NEAR-END CROSSTALK (PSNEXT) LOSS, EQUAL-LEVEL FAR-END CROSSTALK (ELFEXT), POWER SUM FOLIAL-LEVEL FAR-END CROSSTALK (PSELEEXT). RETURN LOSS, PROPAGATION DELAY, AND DELAY SKEW. DOCUMENT AND SUBMIT TEST RESULTS.

#### 10. FIRE ALARM

- THE EXISTING FIRE ALARM SYSTEM IS A SIMPLEX 4100U INTELLIGENT ADDRESSIBLE SYSTEM. NEW DEVICES INSTALLED SHALL BE COMPATIBLE WITH AND LISTED FOR USE WITH THE EXISTING FIRE ALARM SYSTEM.

  NEW INITIATION DEVICES SHALL INCLUDE PHOTOELECTRIC
- SMOKE DETECTORS.
- NEW SIGNALING DEVICES SHALL INCLUDE HORNSTROBES AND SIGNALING LINE AND NOTIFICATION CIRCUITS SHALL MATCH THE
- CLASS AND STYLE OF THE EXISTING SYSTEM.
- FIRE ALARM WIRING SHALL BE ROUTED IN CONDUIT, OR FIRE
- AFTER INSTALLATION OF NEW DEVICES, TEST FIRE ALARM SYSTEM IN ACCORDANCE WITH NEPA 72 AND NEC ARTICLE 760 SUBMIT ALL REQUIRED DOCUMENTATION TO THE AUTHORITY HAVING JURISDICTION (AHJ) AND OWNER

#### 11 IDENTIFICATION

COLOR CODE SECONDARY PHASE CONDUCTORS FOR FEEDERS
AND BRANCH CIRCUITS. COLORING SHALL BE FACTORY
APPLIED FOR SMALL CONDUCTORS. PHASE CONDUCTORS 8AWG AND LARGER AND NEUTRAL AND GROUND CONDUCTORS 4AWG AND LARGER MAY BE FIELD APPLIED USING COLORED PRESSURE-SENSITIVE PLASTIC TAPE. CONDUCTORS SHALL BE COLORED:

208/120-VOLT BLACK

PHASE B: RED PHASE C:

GROUND: GREEN

- 14.1. POWER CIRCUITS SHALL BE IDENTIFIED IN JUNCTION AND DEVICE BOXES, MANHOLES, AND PANELBOARDS WITH THE PANEL AND CIRCUIT NUMBER. TELECOMMUNICATIONS AND ALARM CIRCUITS SHALL BE IDENTIFIED IN JUNCTION AND DEVICE BOXES MANHOLES FOLLIPMENT RACKS AND PANELS WITH THE
- CIRCUIT DESIGNATION. IDENTIFICATION SHALL BE BY:

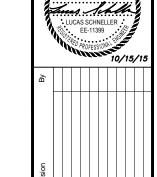
  14.1.1. INTERIOR: PRE-PRINTED WRAPAROUND ADHESIVE LABELS.

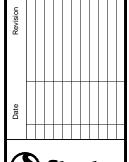
  14.2. EQUIPMENT LABELS SHALL BE ENGRAVED PLASTIC LAMINATE, WHITE LETTERING ON A BLACK FIELD. TEXT SHALL BE 1/2" HIGH ON A 1-1/2" HIGH LABEL. LABELS WITH TWO LINES OF TEXT SHALL USE A 2" HIGH LABEL. EQUIPMENT LABELS SHALL BE PLACED ON SWITCHBOARDS, PANELBOARDS, MOTOR STARTERS, DISCONNECTS, CONTACTORS, AND SYSTEM PANELS
- DEVICE COVERS SHALL BE LABELED WITH THE PANEL AND CIRCUIT NUMBER LABELS SHALL BE MACHINE-PRINTED PRESSURE-SENSITIVE ADHESIVE LABELS, BLACK LETTERING ON A CLEAR BACKGROUND.
- IN UNFINISHED AND CONCEALED AREAS, PAINT COVERS OF JUNCTION BOXES TO IDENTIFY USE:
- FIRE ALARM: RED.
  TELECOMMUNICATIONS: BLUE.
- LOW-VOLTAGE CONTROLS: GREEN.
- PROVIDE TYPEWRITTEN CIRCUIT DIRECTORIES UNDER PLASTIC IN FRAMES FOR EACH NEW AND MODIFIED PANELBOARD. HANDWRITTEN DIRECTORIES OR CHANGES TO EXISTING DIRECTORIES ARE NOT ACCEPTABLE.
- 15. PROJECT COMPLETION / TESTING AND ACCEPTANCE UPON PROJECT COMPLETION, CLEAN ALL ELECTRICAL

INSPECTION AND ACCEPTANCE

- EQUIPMENT AND FIXTURES AND REPLACE OR REPAIR ANY ITEMS SCRATCHED, DENTED, OR OTHERWISE DISFIGURED.
  TEST ALL SYSTEMS TO ASSURE PROPER OPERATION. TEST
- MODIFIED PORTIONS OF EXISTING SYSTEMS UNLESS OTHERWISE DIRECTED
- NOTIFY OWNER OF TEST SCHEDULE AND PROVIDE WRITTEN TEST REPORTS, INCLUDE DEFICIENCIES IDENTIFIED AND ACTIONS TAKEN TO OBTAIN ACCEPTABLE RESULTS COMMISSION ELECTRICAL SYSTEMS IN ACCORDANCE WITH NECA 90 GUIDELINES. DURING FINAL INSPECTION,
- DEMONSTRATE SATISFACTORY OPERATION OF ENTIRE INSTALLATION. REPAIR OR REPLACE FAILED ITEMS AND REPAIR ALL CONSTRUCTION DAMAGE.

  MAINTAIN RED-LINED AS-BUILT RECORD DRAWINGS AS PROJECT PROGRESSES AND DELIVER TO OWNER AFTER FINAL







Anchorage, Alaska 99503 (907) 276-4245 544 4th Avenue.

Fairbanks, Alaska 99701 (907) 452-2128

3017 Clinton Drive Suite 201 Juneau, Alaska 99801 (907) 790-2901 351 W. Parks Highway Suite 200 Wasilla, Alaska 99654 (907) 376-7815

#### CHIEF PETER JOHN TRIBAL BUILDING

#### 5TH FLOOR LOBBY RENOVATION

Project No. 01124 08278 00258 TANANA CHIEFS CONFERENCE 122 1ST AVENUE FAIRBANKS, AK 99701

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Project Mgr.	VANDERWEE		
Drawn	DGB		
Checked	LPS		
Date	10/15	/2015	

#### **ELECTRICAL SPECIFICATIONS**

Sheet Contents:

### ATTACHMENT B

# CPJTB 5<sup>th</sup> FLOOR RESTROOM PHOTOS



**Restroom Partitions** 



Wash Area



Sanitary Napkin Vendor



Entry/Baby Changing Area



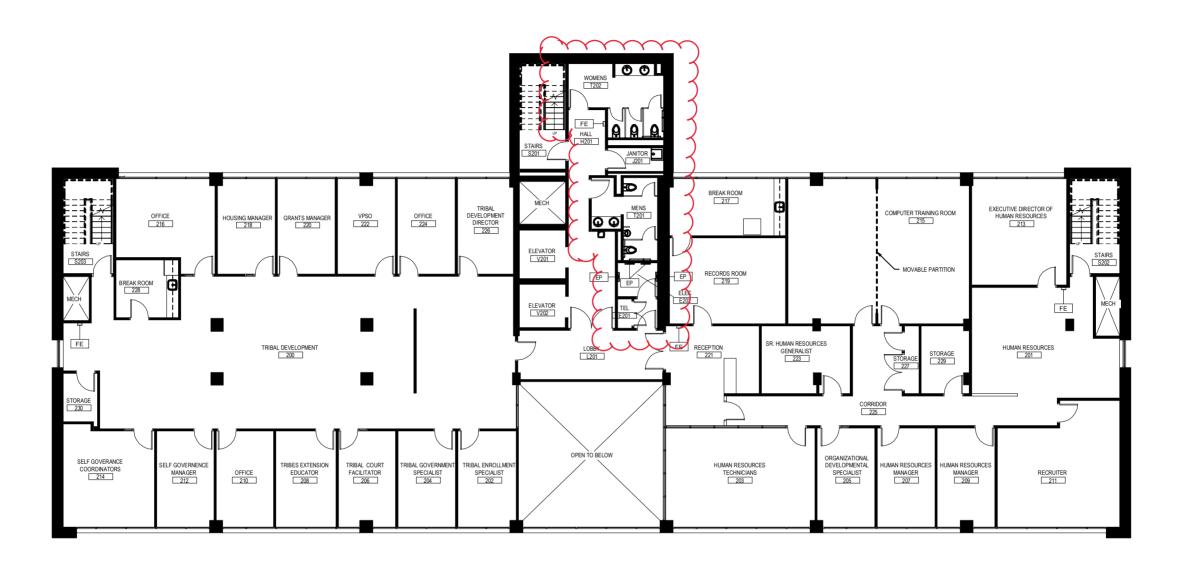
Handicap Restroom



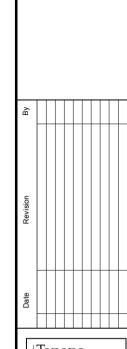
Lighting and Ceiling



Lighting and Ceiling







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Sheet Contents:

2ND FLOOR PLAN

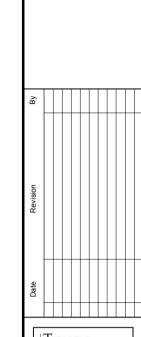
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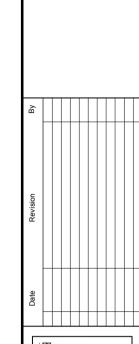
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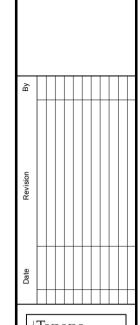
4TH FLOOR PLAN

FLOOR 4

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6TH FLOOR PLAN

FLOOR 6

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